

# BIDDING DOCUMENTS

One Job Order for the

#### CONSTRUCTION AND IMPROVEMENT OF GREGORIO MATAS DISTRICT HOSPITAL located at POBLACION, KIBLAWAN, DAVAO DEL SUR

all in accordance to plans, specifications and scope of work and the Green Procurement Policy as adopted by Executive Order No. 30 series of 2019

IB No. C-003-24

Date of Opening of Bids: March 05, 2024 at 09:00 A.M.

Start Date for Issuance of Bidding Documents: February 09, 2024

Sixth Edition
July 2020

## TABLE OF CONTENTS

SECTION I. INVITATION TO BE

SECTION II. **INSTRUCTIONS TO BIDDERS** 

SECTION III. 

SECTION IV. GENERAL CONDITIONS OF CONTRACT

SECTION Y SPECIAL CONDITIONS OF CONTRACT

SECTION Y SPECIFICATIONS

SECTION SET 

SECTON SET BILL OF QUANTITIES


CHECKLIST OF TECHNICAL AND FINANCIAL DOCUMENTS

SECTION X OTHER DOCUMENTS

### SECTION.

# INVITATION TO BID

工

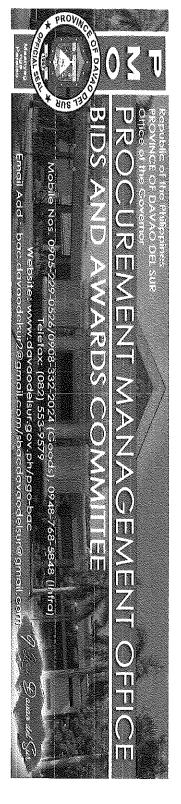

# Invitation to Bid for C-003-24

Executive Order No. 30 series of 2019

## CONSTRUCTION AND IMPROVEMENT OF GREGORIO MATAS DISTRICT HOSPITAL located at POBLACION, KIBLAWAN, DAVAO DEL SUR

all in accordance to plans, specifications and scope of work and the Green Procurement Policy as adopted by Executive Order No. 30 series of 2019

- <del>---</del> received in excess of the ABC shall be automatically rejected at bid opening. Budget for the Contract (ABC) to payments under the contract for IB No. C-003-24. Bids The Provincial Government of Davao del Sur, through the CY 2022 Supplemental Budget 20% Development Fund intends to apply the sum of P9.250,000.00 being the Approved
- 5 bidder is contained in the Bidding Documents, particularly, in Section II (Instructions to Bidders should have completed a contract similar to the Project. The <u>Provincial Government of Davao del Sur</u> now invites bids for the above Procurement Project. Completion of the Works is required <u>180 Calendar Davs Contract Duration</u>. Bidders). The description of an eligible
- 'n Regulations (IRR) of Republic Act (RA) No. 9184. discretionary "pass/fail" criterion as specified in the 2016 revised Implementing Rules and Bidding will be conducted through open competitive bidding procedures using non-
- 4 Interested bidders may obtain further information from Provincial Government of Davao del Sur and inspect the Bidding Documents at the address given below during 8:00 A.M. - 5:00 P.M., Monday to Friday:

# Engr. SHIELA MAE A. ZAPANTA, MPA Administrative Officer IV Head, BAC Secretariat for Infrastructure Projects

V markings (Original Copy, Copy 1 and Copy 2), respectively. Any documents submitted not book bound shall be rejected outright. For the Financial Proposals not exceeding ten Financial documents must be book bound and properly tabbed at right side.
will prepare (3) sets of book bound bidding documents with correspond receipt of the bidding documents will be allowed to submit bids. Eligibility/Technical and upon payment of a non-refundable fee for the Bidding Documents in the amount stated above, to the Provincial Treasurer's Office. An authorization from the proprietor of the (10) pages may be book bound or securely stapled. A complete set of Bidding Documents may be acquired by interested bidders on February 09.

March 05, 2024, at the Office of the BAC Secretariat Room 16, Executive Building, Capitol company shall be presented in case the latter opted to send representative/s in his/her behalf. Only bidders who purchased the Bidding Documents with corresponding official Government of Davao del Sur shall allow the bidder to present its proof of payment for the fees Compound, Brgy. Matti, Digos City upon accomplishing a bidder's assessment slip pursuant to the latest Guidelines issued by GPPB, in the amount of **P10,000.00**. The Provincial by. with corresponding proper

- 9 The Provincial Government of Davao del Sur will hold a Pre-Bid Conference on February 20, 2024, 9:00 A.M. at Ralota Hall, Gov. Douglas Ra. Cagas Cultural, Sports and Business Complex, Barangay Matti, Digos City, Davao del Sur, which shall be open to prospective
- 7 submission. Late bids shall not be accepted Bids must be duly received by the BAC Secretariat 21 the following through manual
- Advance dropping (before March 05, 2024) Room 16, Procurement Management
- Office (Infrastructure Projects), Capitol Building, Matti, Digos City Date of opening (March 05, 2024, before 9:00 A.M.) Ralota Coliseum, Matti, Digos City. Ralota Hall, Davao del Sur
- 00 amount stated in ITB Clause 16. All bids must be accompanied by a bid security in any of the acceptable forms and in the
- 9 Cultural, Sports and Business Complex, Barangay Matti, Digos City, Davao del Sur. Bids will be opened in the presence of the bidders' representatives who choose to attend the activity. Bid opening shall be on March 05, 2024 at 9:00 A.M., Ralota Hall, Gov. Douglas Ra. Cagas
- 10. The <u>Provincial Government of Davao del Sur</u> reserves the right to reject any and all bids, declare a failure of bidding, or not award the contract at any time prior to contract award in accordance with Sections 35.6 and 41 of the 2016 revised Implementing Rules and Regulations (IRR) of RA No. 9184, without thereby incurring any liability to the affected bidder or bidders
- 11. For further information, please refer to:

### The BAC CHAIRPERSON

Provincial Government of Davao del Sur Contact No: 09487685848

Email Address: sbacdavaodelsur@gmail.com

## Engr. SHIELA MAE A. ZAPANTA, MPA

Head, BAC Secretariat for Infrastructure Projects PGO -- Procurement Management Office

Office of BAC Secretariat for Infrastructure Projects

Room 16, Provincial Capitol Building, Matti, Digos City, Davao del Sur Contact No: 09487685848; Email Address: sbacdavaodelsur@gmail.com

12. You may Documents. visit the website, www.davaodelsur.gov.ph, for downloading of Bidding

DESSAMIE BUAT-SANCHEZ, CPA, JD Provincial Budget Officer BAC Chairperson

### SECTION II

2

### Section I. Instructions to Bidders

#### 1. Scope of Bid

DISTRICT HOSPITAL located at POBLACION, KIBLAWAN, DAVAO DEL SUR, with Project Identification Number C-003-24. The PROVINCIAL GOVERNMENT OF DAVAO DEL SUR invites Bids for the One Job Order for the CONSTRUCTION AND IMPROVEMENT OF GREGORIO MATAS

KIBLAWAN, DAVAO DEL SUR") is for the construction of Works, as described in Section The Procurement Project (referred to herein as ("CONSTRUCTION AND IMPROVEMENT OF GREGORIO MATAS DISTRICT HOSPITAL located at POBLACION, VI (Specifications).

### 2. Funding Information

- 2.1. of P9,250,000.00. The GOP through the source of funding as indicated below for CY 2022 in the amount
- 2.2 The source of funding is SUPPLEMENTAL BUDGET - 20% DEVELOPMENT

### 3. Bidding Requirements

regulations as the primary source thereof, while the herein clauses shall serve as the secondary revised IRR, source thereof. The Bidding for the Project shall be governed by all the provisions of RA No. 9184 and its 2016 including its Generic Procurement Manual and associated policies, rules

supplemental or bid bulletin. ongoing posting, Any amendments made to the IRR and other GPPB issuances shall be applicable only to the advertisement, or invitation to bid by the BAC through the issuance of a

duration and execution or implementation of the contract, project, or work and examine all determined the general characteristics of the contracted Works and the conditions for this Project, instructions, forms, terms, and project requirements in the Bidding Documents labor, water, electric power and access roads; facilities, requirements, location and availability of construction aggregates and other materials, facilities; (c) nature and condition of the terrain, geological conditions at the site communication The Bidder, the location and the nature of the work; (b) climatic conditions; (c) transportation by the act of submitting its Bid, shall be deemed to have inspected the site, and (d) other factors that may affect the cost,

## Þ Corrupt, Fraudulent, Collusive, Coercive, and Obstructive Practices

not engage in corrupt, fraudulent, collusive, coercive, and obstructive practices defined under Annex "I" of the 2016 revised IRR of RA No. 9184 or other integrity violations in competing of ethics during the procurement and execution of the contract. They or through an agent shall The Procuring Entity, as well as the Bidders and Contractors, shall observe the highest standard for the Project.

### Eligible Bidders

- 5.1. Only Bids of Bidders found to be legally, technically, and financially capable will be
- 5.2 Contract (SLCC) that is similar to this Project, equivalent to at least fifty percent (50%) of the ABC adjusted, if necessary, by the Bidder to current prices using the PSA's CPI, The Bidder must have an experience of having completed a Single Largest Completed

No. 9184. except under conditions provided for in Section 23.4.2.4 of the 2016 revised IRR of RA

categories of work stated in the BDS A contract is considered to be "similar" to the contract to be bid if it has the major

- 53. record requirement, as specified in the Bidding Document prepared for this purpose government/foreign or international financing institution may agree on another track Foreign-funded Procurement, the Procuring Entity and
- 5.4 IRR of RA No. 9184. The Bidders shall comply with the eligibility criteria under Section 23.4.2 of the 2016

## 6. Origin of Associated Goods

There is no restriction on the origin of Goods other than those prohibited by a decision of the UN Security Council taken under Chapter VII of the Charter of the UN.

### 7. Subcontracts

7.1. Subcontracting is not allowed.

### 8. Pre-Bid Conference

at 9:00 A.M., Ralota Hall, Gov. Douglas Ra. Cagas Cultural Sports and Business Complex, Barangay Matti, Digos City, Davao del Sur as indicated in paragraph 6 of the IB The Procuring Entity will hold a pre-bid conference for this Project on the February 20, 2024,

### Ö Clarification and Amendment of Bidding Documents

Bidding Documents. Such requests must be in writing and received by the Procuring Entity, either at its given address or through electronic mail indicated in the IB, at least ten (10) Prospective bidders may request for clarification on and/or interpretation of any part of the calendar days before the deadline set for the submission and receipt of Bids

## Documents Comprising the Bid: Eligibility and Technical Components

- 10.1. specified in Section IX. Checklist of Technical and Financial Documents. The first envelope shall contain the eligibility and technical documents of the Bid as
- 10.2. authenticated through an apostille pursuant to GPPB Resolution No. 13-2019 dated 23 appropriate Philippine foreign service establishment, If the eligibility requirements or statements, the bids, and all other documents having jurisdiction over the foreign bidder's affairs in the Philippines. For Contracting May 2019. The English translation shall govern, for purposes of interpretation of the accompanied by a translation in English, submission to the BAC are in foreign language other than English, it must be the Apostille Convention, only which shall be the translated post, or the equivalent office authenticated by documents
- 10.3. and cost of the contract for this Project. Any additional type of permit shall be indicated in the BDS A valid special PCAB License in case of Joint Ventures, and registration for the type Contractor license
- 10.4 must meet the required minimum years of experience set in the BDS materials Engineers, and Foremen) assigned to the contract to be bid, with their complete qualification and experience data shall be provided. These key personnel List of Contractor's key personnel (e.g., Project Manager, Project Engineers,

10.5. A List of Contractor's major equipment units, which are owned, leased, and/or under may be, must meet the minimum requirements for the contract set in the BDS equipment from the equipment lessor/vendor for the duration of the project, as the case purchase agreements, supported by proof of ownership, certification of availability of

### **Documents Comprising the Bid: Financial Component**

- 11.1. in Section IX. Checklist of Technical and Financial Documents. The second bid envelope shall contain the financial documents for the Bid as specified
- 112 Any bid exceeding the ABC indicated in paragraph 1 of the IB shall not be accepted
- 11.3. For Foreign-funded procurement, a ceiling may be applied to bid prices provided the conditions are met under Section 31.2 of the 2016 revised IRR of RA No. 9184.

### 12. Alternative Bids

there is a value engineering clause in the BDS, alternative Bids shall not be accepted including the basic technical design as indicated in the drawings and specifications. Bidders shall submit offers that comply with the requirements of the Bidding Documents, Unless

#### 13. Bid Prices

pursuant to the revised Guidelines for Contract Price Escalation guidelines prices, and therefore not subject to price escalation during contract implementation, except under extraordinary circumstances as determined by the NEDA and approved by the GPPB All bid prices for the given scope of work in the Project as awarded shall be considered as fixed

## 14. Bid and Payment Currencies

- 14.1. Bid prices may be quoted in the local currency or tradeable currency accepted by the BSP at the discretion of the Bidder. However, for purposes of bid evaluation, Bids denominated in foreign currencies shall be converted to Philippine currency based on the exchange rate as published in the BSP reference rate bulletin on the day of the bid
- 14.2. Payment of the contract price shall be made in: Philippine Pesos.

#### 15. Bid Security

- 15.1. The Bidder shall submit a Bid Securing Declaration or any form of Bid Security in the accordance with the schedule in the BDS amount indicated in the BDS, which shall be not less than the percentage of the ABC in
- 15.2 The Bid and bid security shall be valid for 120 Calendar Days upon opening of bids. Any bid not accompanied by an acceptable bid security shall be rejected by the Procuring Entity as non-responsive.

## 16. Sealing and Marking of Bids

However, failure of the Bidders to comply with the said request shall not be disqualification. Each Bidder shall submit one copy of the first and second components of its Entity may request additional hard copies and/or electronic copies of the Bid. a ground for

website or any other electronic means, the Bidder shall submit an electronic copy of its Bid If the Procuring Entity allows the submission of bids through online submission to the



which must be digitally signed. An electronic copy that cannot be opened or is corrupted shall be considered non-responsive and, thus, automatically disqualified.

٠.

## 17. Deadline for Submission of Bids

in any of the acceptable forms and in the amount stated in ITB Clause 18. at 9:00 A.M. Late bids shall not be accepted. All bids must be accompanied by a bid security Business Complex, Bids must be delivered to the Ralota Hall, Gov. Douglas Ra. Cagas Cultural Sports and Barangay Matti, Digos City, Davao del Sur on or before March 05, 2024

### <u>00</u> Opening and Preliminary Examination of Bids

18.1.The recorded by the BAC Secretariat. other similar technologies will be used, attendance of participants shall likewise be sign a register evidencing their attendance. In case videoconferencing, webcasting or specified in paragraph 9 of the IB. The Bidders' representatives who are present shall BAC shall open the Bids Ħ public at the time, on the date, and at the place

in case the Bids cannot be opened as scheduled due to justifiable reasons, the rescheduling requirements under Section 29 of the 2016 revised IRR of RA No. 9184 shall prevail.

18.2. revised IRR of RA No. 9184 The preliminary examination of Bids shall be governed by Section 30 of the 2016

### Detailed Evaluation and Comparison of Bids

- 19.1. rated "passed" using non-discretionary pass/fail criteria. The BAC shall consider the conditions in the evaluation of Bids under Section 32.2 of 2016 revised IRR of RA No. The Procuring Entity's BAC shall immediately conduct a detailed evaluation of all Bids The BAC shall consider the
- 19.2. If the Project allows partial bids, all Bids and combinations of Bids as indicated in the BDS shall be received by the same deadline and opened and evaluated simultaneously so as to determine the Bid or combination of Bids offering the lowest calculated cost to the Procuring Entity. Bid Security as required by ITB Clause 15 shall be submitted for each contract (lot) separately.
- 19.3. In all cases, the NFCC computation pursuant to Section 23.4.2.6 of the 2016 revised participated in by the prospective Bidder IRR of RA No. 9184 must be sufficient for the total of the ABCs for all the lots

### 20. Post Qualification

in the BDS Payment System (eFPS), and other appropriate licenses and permits required by law and stated latest income and business tax returns filed and paid through the BIR Electronic Filing and Within a non-extendible period of five (5) calendar days from receipt by the Bidder of the from the BAC that it submitted the Lowest Calculated Bid, the Bidder shall submit its

### 21. Signing of the Contract

part of the Contract. Additional Contract documents are indicated in the BDS The documents required in Section 37.2 of the 2016 revised IRR of RA No. 9184 shall form

T

## SECTION II.

# BID DATA SHEET

1

### Bid Data Sheet (IB No.: C-003-24)

Su		21 1. On CC	Po Re	In : aw 20 <i>Per</i>	19.2 Par and eve	 Ф	15.1   The the a.	12 None	# <u>N</u>	10.5 The	10.4 Like	7.1 Su	(ba	<b>B</b>	5.2 For the	ause
Such documents shall be duly signed by the bidders or its duly authorized	b. Envelope 2 (Financial Proposal) One (1) ORIGINAL COPY, another copy for COPY 1, and another copy for COPY 2.	1. Presentation of the Bidding Documents  a. Envelope 1 (Eligibility/ Technical Documents) One (1) ORIGINAL COPY, another copy for COPY 1, and another copy for COPY 2.	Post-Qualification Requirements: Latest Income Tax Returns, Business Tax Returns for the last 6 months.	In all cases, the NFCC computation must be sufficient for the contract to be awarded to the Bidder.  Permits and Clearances as required by the End-User.	Partial bid is not allowed. The infrastructure project is packaged in a single lot and the lot shall not be divided into sub-lots for the purpose of bidding, evaluation, and contract award.	o. The amount of <b>not less than P462,500.00</b> [five percent (5%) of ABC], if bid security is in Surety Bond.	The bid security shall be in the form of a Bid Securing Declaration or any of the following forms and amounts:  a. The amount of <b>not less than P185,000.00</b> [two percent (2%) of ABC], if bid security is in cash, cashier's/manager's check, bank draft/guarantee or irrevocable letter of credit;	ne.	Equipment Capacity Number of Units "No further instructions."	"No further instructions."  The minimum major equipment requirements are the following:	below:  Key Personnel General Experience Relevant Experience	Subcontracting is not allowed.	(based on DPWH DO 14 Series of 2017)	Buildings: Construction or Repair	For this purpose, contracts similar to the Project refer to contracts which nave the same major categories of work, which shall be:	

representative/s.

maybe book bound or securely stapled. Eligibility/Technical and Financial Proposal must be book bound and properly tabbed at the right side. Any documents submitted not book bound shall be rejected outright. For the Financial Proposal not exceeding ten (10) pages

All copies must be properly marked (ORIGINAL COPY, COPY 1 AND COPY 2)

one sealed mother envelope. Envelope 1 and Envelope 2 must be properly sealed, and will be placed in

- and requirements as stated in the Instruction to Bidders: Other documents/materials to comply with other non-discretionary criteria
- **Construction Methods**
- Construction schedule and S-Curve
- Pert-CPM
- Manpower Utilization Schedule
- **Equipment Utilization Schedule**
- Construction Safety & Health Program
- **Affidavit of Site Inspection**
- The DOLE approved Construction Safety Standard Duly Notarized Certification as to compliance to Labor Laws and and Health Program is required

before entering into Contract.

T

### SECTION IV.

### GENERAL CONDITIONS OF CONTRACT

J.

# General Conditions of Contract

### 1. Scope of Contract

clauses shall serve as the secondary source for the terms and conditions of the Contract. reasonably inferred as being required for its completion as if such items were expressly mentioned herein. All the provisions of RA No. 9184 and its 2016 revised IRR, including the terms and conditions of the Contract, and thus, applicable in contract implementation. Generic Procurement Manual, and associated issuances, constitute the primary source for the This Contract shall include all such items, although not specifically mentioned, that can be Herein

allowing the GPPB to amend the IRR, which shall be applied to all procurement activities, the advertisement, posting, or invitation of which were issued after the effectivity of the said This is without prejudice to Sections 74.1 and 74.2 of the 2016 revised IRR of RA No. 9184

## 2. Sectional Completion of Works

Intended Completion Date for the whole of the Works). shall apply to any Section of the Works (other than references to the Completion Date and Conditions of Contract to the Works, the Completion Date, and the Intended Completion Date If sectional completion is specified in the Special Conditions of Contract (SCC), references in the

### 3. Possession of Site

- 3.1 The Procuring Entity shall give possession of all or parts of the Site to the Contractor based on the schedule of delivery indicated in the SCC, which corresponds to the execution of the Works. If the Contractor suffers delay or incurs cost from failure on the and certify such sum as fair to cover the cost incurred, which sum shall be paid by part of the Procuring Entity to give possession in accordance with the terms of this clause, the Procuring Entity's Representative shall give the Contractor a Contract Time Extension Procuring Entity.
- 3.2 under Annex "E" of the 2016 revised IRR of RA No. 9184 contract time to address such delay may be addressed through contract extension provided If possession of a portion is not given by the above date, the Procuring Entity will be deemed to have delayed the start of the relevant activities. The resulting adjustments in

## 4. The Contractor's Obligations

carry out the supervision of the Works indicating their designation, in accordance with ITB Clause 10.3 and specified in the BDS, to Contractor shall employ the key personnel named in the Schedule of Key Personnel

The Procuring Entity will approve any proposed replacement of key personnel only if their relevant qualifications and abilities are equal to or better than those of the personnel listed in the

### 5. Performance Security

Entity but in no case later than the signing of the contract by both parties, the successful Within ten (10) calendar days from receipt of the Notice of Award from the Procuring



of the 2016 revised IRR. Bidder shall furnish the performance security in any of the forms prescribed in Section 39

5.2 subcontractor be they an individual, firm, partnership, corporation, or association supplying the Contractor with labor, materials and/or equipment for the performance of right of the Procuring Entity to institute action pursuant to RA No. 3688 The Contractor, by entering into the Contract with the Procuring Entity, acknowledges the this Contract. against any

### 6. Site Investigations

the SCC supplemented by any information obtained by the Contractor. The Contractor, in preparing the Bid, shall rely on any Site Investigation Reports referred to in

#### 7. Warranty

- 7.1. In case the Contractor fails to undertake the repair works under Section 62.2.2 of the 2016 participating in any public bidding. All payables of the GOP in his favor shall be offset to revised IRR, recover the costs. property(ies) to attachment or garnishment proceedings, and perpetually disqualify it from the Procuring Entity shall forfeit its performance security, subject its
- 7.2. Acceptance by the Procuring Entity. majeure, shall cover the period from the date of issuance of the Certificate of Final The warranty against Structural Defects/Failures, Specific duration of the warranty is found in the except that occasioned-on

### 8. Liability of the Contractor

Contract shall be as provided by the laws of the Republic of the Philippines. Subject to additional provisions, if any, set forth in the SCC, the Contractor's liability under this

liable to the Procuring Entity. If the Contractor is a joint venture, all partners to the joint venture shall be jointly and severally

## 9. Termination for Other Causes

to corrupt, fraudulent, collusive, coercive, and obstructive practices as stated in ITB Clause 4. that the Contractor has engaged, before, or during the implementation of the contract, in unlawful deeds and behaviors relative to contract acquisition and implementation, such as, but not limited Contract termination shall be initiated in case it is determined prima facie by the Procuring Entity

#### 10. Dayworks

be used for small additional amounts of work only when the Procuring Entity's Representative has given written instructions in advance for additional work to be paid for in that way. 9184, and if applicable as indicated in the SCC, the Dayworks rates in the Contractor's Bid shall Subject to the guidelines on Variation Order in Annex "E" of the 2016 revised IRR of RA No.

J

### 11. Program of Work

- 11.1. . 000 000 The Contractor shall submit to the Procuring Entity's Representative for approval the said Program of Work showing the general methods, arrangements, order, and timing for all the activities in the Works. The submissions of the Program of Work are indicated in the
- 11.2. updated Program of Work at intervals no longer than the period stated in the SCC. If the Contractor does not submit an updated Program of Work within this period, the Procuring Entity's Representative may withhold the amount stated in the SCC from the next payment certificate and continue to withhold this amount until the next payment after the The Contractor shall submit to the Procuring Entity's Representative for approval an date on which the overdue Program of Work has been submitted.

# 12. Instructions, Inspections and Audits

and records relating to the performance of the Contractor and to have them audited by auditors of the GOP or the Procuring Entity, as may be required. The Contractor shall permit the GOP or the Procuring Entity to inspect the Contractor's accounts

### 13. Advance Payment

installments according to a schedule specified in the SCC, subject to the requirements in Annex fifteen percent (15%) of the total contract price, to be made in lump sum, or at the most two a Contract document, make an advance payment to the Contractor in an amount not exceeding "E" of the 2016 revised IRR of RA No. 9184. The Procuring Entity shall, upon a written request of the Contractor which shall be submitted as

### 14. Progress Payments

site but not completely put in place shall not be included for payment. Engineer. The Contractor may submit a request for payment for Work accomplished. payment shall be verified and certified by the Procuring Entity's Rep Except as otherwise stipulated in the SCC, materials and equipment delivered on the Procuring Entity's Representative/Project Such requests for

# 15. Operating and Maintenance Manuals

- 15.1. If required, maintenance manuals as specified in the SCC the Contractor will provide "as built" Drawings and/or operating and
- 15.2 payments due to the Contractor. If the Contractor does not provide the Drawings and/or manuals by the dates stated Procuring O. Entity's Representative may they do not receive the Procuring Entity's Representative's approval, withhold the amount stated in the (N)



### SECTION Y.

### SPECIAL CONDITIONS OF CONTRACT

F

# Special Conditions of Contract

"No further instructions."	15.2
The date by which "as built" drawings are required is 15 days prior turn-over and acceptance.	
"No further instructions."	15.1
Materials and equipment delivered on the site but not completely put in place shall not be included for payment.	12
The amount of the advance payment shall not exceed Fifteen Percent (15%) of the total contract price to be recouped every progress billing.	13
"No further instruction."	11.2
"No further instruction."	p-resid p-resid - - Jaconsk
a.Dayworks are applicable at the rate shown in the Contractor's original Bid.	10
concrete/asphalt roads, concrete river control, drainage, irrigation lined canals, river landing, deep wells, rock causeway, pedestrian overpass, and other similar semi-permanent structures:] Five (5) years.	
[In case of semi-permanent structures, such as buildings of types 1, 2, and 3 as classified under the National Building Code of the Philippines,	7.2
The site investigation reports are: Site Inspection Report	6
The Procuring Entity shall give possession in full the parts of the Site to the Contractor upon receipt of the Notice to Proceed.	4.1
The Intended Completion Date is 180 calendar days upon receipt of the Notice to Proceed.	2
	GCC Clause

### SECTION VI

# SPECIFICATIONS

[See attached file.]

7.

Name of Project : CONSTRUCTION AND IMPROVEMENT OF GREGORIO MATAS DISTRICT HOSPITAL Location : POBLACION, KIBLAWAN, DAVAO DEL SUR

### SPECIFICATIONS

## 1. SEPTIC TANK FOR DORMITORIES (3 DORMS)

1.00	l.s.	Septic Vault	1001(11)
21.00	sq.m.	Formworks and Falseworks	903(2)
39.90	cu.m.	Structure Excavation, (Common Soil)	803(1)a
1.00	ı.s.	Mobilization / Demobilization	B.9
1.00	ı.s.	Occupational Safety and Health	B.7
1.00	each	Project Billboard/Signboard	B.5
1.00	l.s	Permits and Clearances	B.3
Quantity	Unit	Description	Item

#### 2. CONCRETE ROAD

Item	Description	Unit	Quantity
100(1)	Clearing & Grubbing (with Stripping)	ha.	e e
102(2)	Surplus Common Excavation	cu.m.	Contract of the contract of th
104(1)a	Embankment from roadway excavation (Common Soil)	m.mo	
105(1)a	Subgrade Preparation (Common Material)	sq.m.	
200(1)	Aggregate Subbase Course	cu.m	
311(1)b1	Portland Cement Concrete Pavement (Unreinforced), 200mm thk.	sq:m.	

## 3. PERIMETER FENCE WITH SOLAR LIGHTS

34.00	each	Solar LED Street Light (Integrated Street Light)	624(8)
236.06	sq.m.	Painting Works, Steel	1032(1)c
1510.76	sq.m.	Painting Works, Masonry/Concrete	1032(1)a
1.00	l.s.	Structural Steel	1047(1)
1510.76	sq.m.	Cement Plaster Finish	1027 (1)
623.18	sq.m.	CHB Non Load Bearing (including Reinforcing Steel),100 mm	1046(2)a1
373.86	sq.m.	Formworks and Falseworks	903 (2)
4289.61	kg	Reinforcing Steel (Deformed) Grade 40	902 (1)a1
46.71	cu.m.	Structural Concrete ,Class A, 3000 psi, 28 days	900 (1)c
12.20	cu.m.	Gravel Fill	804 (4)
104.26	cu.m.	Structure Excavation (Common Soil)	803 (1)a
1.00	.s.	Clearing and Grubbing	800 (2)
Quantity	Unit	Description	Item
		AND THE PROPERTY OF THE PROPER	

### 4. CADAVER HOLDING AREA

1003(2)f	1003(1)b1	1002(27)	1002(24)	1002(4)	1001(11)	903(2)	902(1)a1	900(1)c	804(7)	803(1)a	800(2)	Item
 Wall, Metal Cladding	_4.5mm Fiber Cement Board on Metal Frame Ceiling	Plumbing Works	Cold Water Lines	Plumbing Fixtures	Septic Vault	Formworks and Falseworks	Reinforcing Steel (Deformed) Grade 40	Structural Concrete, Class A,3000 psi, 28 Days	Gravel Fill	Structure Excavation, (Common Soil)	Clearing and Grubbing	Description
sq.m.	sq.m.	l.s.	ï.s.	i.s.	l.s.	i.s.	kgs.	Çd.m.	cu.m.	cd.m.	I.S.	Unit
7.86	68.34	1.00	1.00	1.00 0000	1.00	1.00	839.03	11.76	8.02	7.95	1.00	Quantity

1103 (1)	1102 (1)	1101(33)	1100 (10)	1047 (1)	1046(2)a1	1038(1)	1032(1)c	1032(1)b	1032(1)a	1027(1)	1018 (5)	1014(1)b2	1013 (2) a1	1010(2)b	1010(1)	1008(1)a	1003 (17)	•
Lighting Fixtures	Panelboard with Main & Branch Breakers	Wires and Wiring Devices	Conduits, Boxes & Fittings (Conduit Works/Conduit Rough-In)	Structural Steel	CHB Non-Load Bearing(Including reinforcing Steel),100mm	Reflective Insulation	Painting Works, Metal	Painting Works, Wood	Painting Works, Masonry/Concrete	Cement Plaster Finish	Glazed Tiles	Pre-painted Metal Sheets, above 0.427 mm, Rib Type, Long Span	Fabricated Metal Roofing Accessory (Gauge 26 (0.551 mm), Ridge Roll)	Doors (Wood Panel)	Frames (Jambs, Sills, Head Transoms and Mullions)	Aluminum Glass Window (Sliding Type)	Carpentry & Joinery Works	1 2
S	1.5.	i.s.	l.s.	·s.	sq.m.	sq.m.	sq.m.	sq.m.	sq.m.	sq.m.	sq.m.	sq.m.	sq.m.	sq.m.	set	sq.m.	l.s.	2 - 1
S	SO.	S	is.	1.00	109.49	68.34	6.48	16.98	268.34	200.00	38.40	80.77	10.30	2.73	6.00	4.32	1:00	

#### 5. PRAYER ROOM

SPL-1	1047(1)	1032(1),	1032(1)b	1018(2)	1014(1)b2	1003(17)	1003(2)f	903(2)	902(1)a1	900(1)c	804(7)	803(4)a	ltem
Acrylic Signages	Structural Steel	Painting Works, Steel	Painting Works, Wood	Unglazed Tiles	Pre-painted Metal Sheets, above 0.427 mm, Rib	Carpentry and Joinery Works	Wall, Metal Cladding	Formworks and Falseworks	Reinforcing Steel (Deformed), Grade 40	Structural Concrete, Class A, 3000 psi, 28 days	Gravel Fill	Structure Excavation (Common Soil)	Description
CIS.	i.s.	sq. m.	sq. m	sq. m	sq. m.	lump sum	sg. m.	lump sum	kilogram	cu.m.	cu.m.	cu.m.	Unit
1.00	1.00	57.80	38.32	24.00	36.11	1.00	31.01	1.00	109.66	271	11.76	1.00	Quantity

### 6. DRAINAGE/CANAL WITH COVER

503(1)	405(1)c1	404(1)a	103(1)	ltem
Metal Frame and Grating	Structural Concrete Class "B" (7 days)	Reinforcing Steel Bar, Grade 40 (Minor Structures)	Structure Excavation	Description
set	cu.m.	kg.	cu.m.	Unit
225.00	85.35	2541.46	160.03	Quantity

#### 7. LANDSCAPING

100000			
38.00	sam	Landscaping	SPL
17.10	cu.m.	Structure Excavation	803(1)a
Quantity	Unit	Description	ltem .

### 8, CONCRETE PATHWAY

*	472.50	kg.	Reinforcing Steel (Deformed ), Grade 40	902(1)a
1	22.20	cu.m	Structural Concrete, Class A, 14 Days	900(1)b1
3,	12.48	cu.m	Gravel fill	804(4)
	33.96	cu.m.	Surplus Common Excavation	802(2)
	1.00	lumpsum	Clearing & Grubbing	800(2)
\[	Quantity	Cnit	Description	ltem

III O N

Specifications shall be in accordance with the DPWH Standard Specifications for Public Works Structures Volume III, 2019 Edition

Prepared by:

REXIE GREY B. TABAY
Architect III

Reviewed by:

JOSEPH R. GONZALES

Approved by:

LEONERL MARCHR, SUARIO
Provincial Engineer

Engineer III.
Planning and Programming Division Head

## SECTION VII.

[The Detailed Engineering Design is available at the Provincial Government of Davao del Sur, Procurement Management Office, Office of the BAC Secretariat for Infrastructure Projects, Room 16, Executive Building of Provincial Capitol, Matti, Digos City, upon purchase of the corresponding bidding documents.]

T



#### PROVINCE OF DAVAO DEL SUR PROVINCIAL ENGINEER'S OFFICE



SAN AGUSTIN, DIGOS CITY, DAVAO DEL SUR

DETAILED ARCHITECTURAL AND ENGINEERING DESIGN

FOR

#### CONSTRUCTION AND IMPROVEMENT OF GREGORIO MATAS DISTRICT HOSPITAL (GMDH)

POBLACION, KIBLAWAN, DAVAO DEL SUR

(SCOPE OF WORKS)

- 1. SEPTIC TANK FOR 3 DORMITORIES
- 2. CONCRETE ROAD
- 3. PERIMETER FENCE WITH SOLAR LIGHTS
- 4. CADAVER HOLDING AREA
- 5. PRAYER ROOM
- 6. DRAINAGE / CANAL WITH COVER
- 7. LANDSCAPING
- 8. CONCRETE PATHWAY

- NET LENGTH = 141.13 M. >
- 310.20 M. WITH 34 UNITS SOLAR LIGHT >
- 61,28 SQ.M. -
- 23.20 SQ.M. >
- 269.55 M. 🗸

- NET LENGTH = 148.0 M. <

RECOMMENDING APPROVAL


PROVINCIAL ENGINEER

APPROVED:


YVONNE ROMA CAGAS PROVINCIAL GOVERNOR

ENGINEER - III
PLANNING AND PROGRAMMING DIV. HEAD

1. SEPTIC TANK FOR DORMITORIES (3 DORMS)

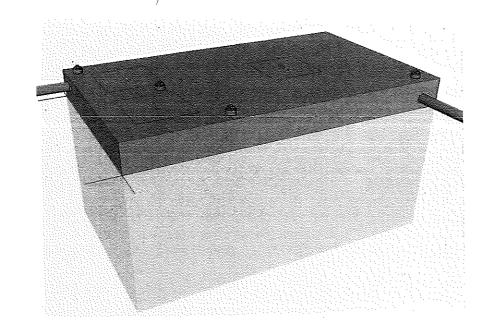



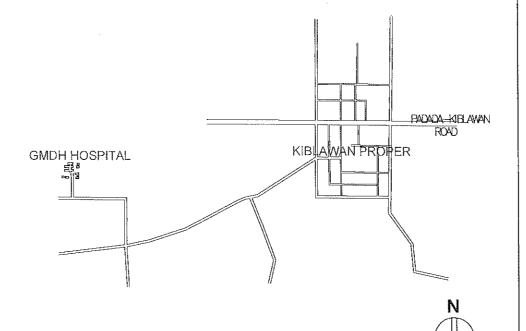



PREPARED BY:

REXIE GREY B. TABAY

SEPH R. GONZALES

PROVINCIAL ENGINEER

RECOMMENDING APPROVAL:

TABLE OF CONTENTS

ARCHITECTURAL

SITE DEVELOPMENT PLAN

SANITARYLINE LAYOUT WATERLINE LAYOUT SEPTIC TANK DETAIL

PROJECT BILLBOARD DETAIL SUMMARY OF QUANTITIES

GENERAL NOTES & SPECIFICATIONS LEGEND

PERSPECTIVE VICINITY MAP

P.0 PLUMBING

OTHER

APPROVED BY:

SHEET NO.:

REPUBLIC OF THE PHILIPPINES
DEPARTMENT OF PUBLIC WORKS AND HIGHWAYS

OFFICE OF THE BUILDING OFFICIAL

DISTRICT/CITY/MUNICIPALITY

LAND USE AND ZONING

LINE AND GRADE

ARCHITECTURAL

STRUCTURAL

SANITARY

ELECTRICAL

MECHANICAL




REPUBLIC OF THE PHILIPPINES PROVINCIAL ENGINEER'S OFFICE SAN AGUSTIN, DIGOS CITY, DAVAO DEL SUR

CONSTRUCTION AND IMPROVEMENT OF GREGORIO MATAS DISTRICT HOSPITAL (GMDH)

POBLACION, KIBLAWAN, DAVAO DEL SUR

ARCHITECT III

ENGINEER III LANNING AND PROGRAMMING DIV, HEAD

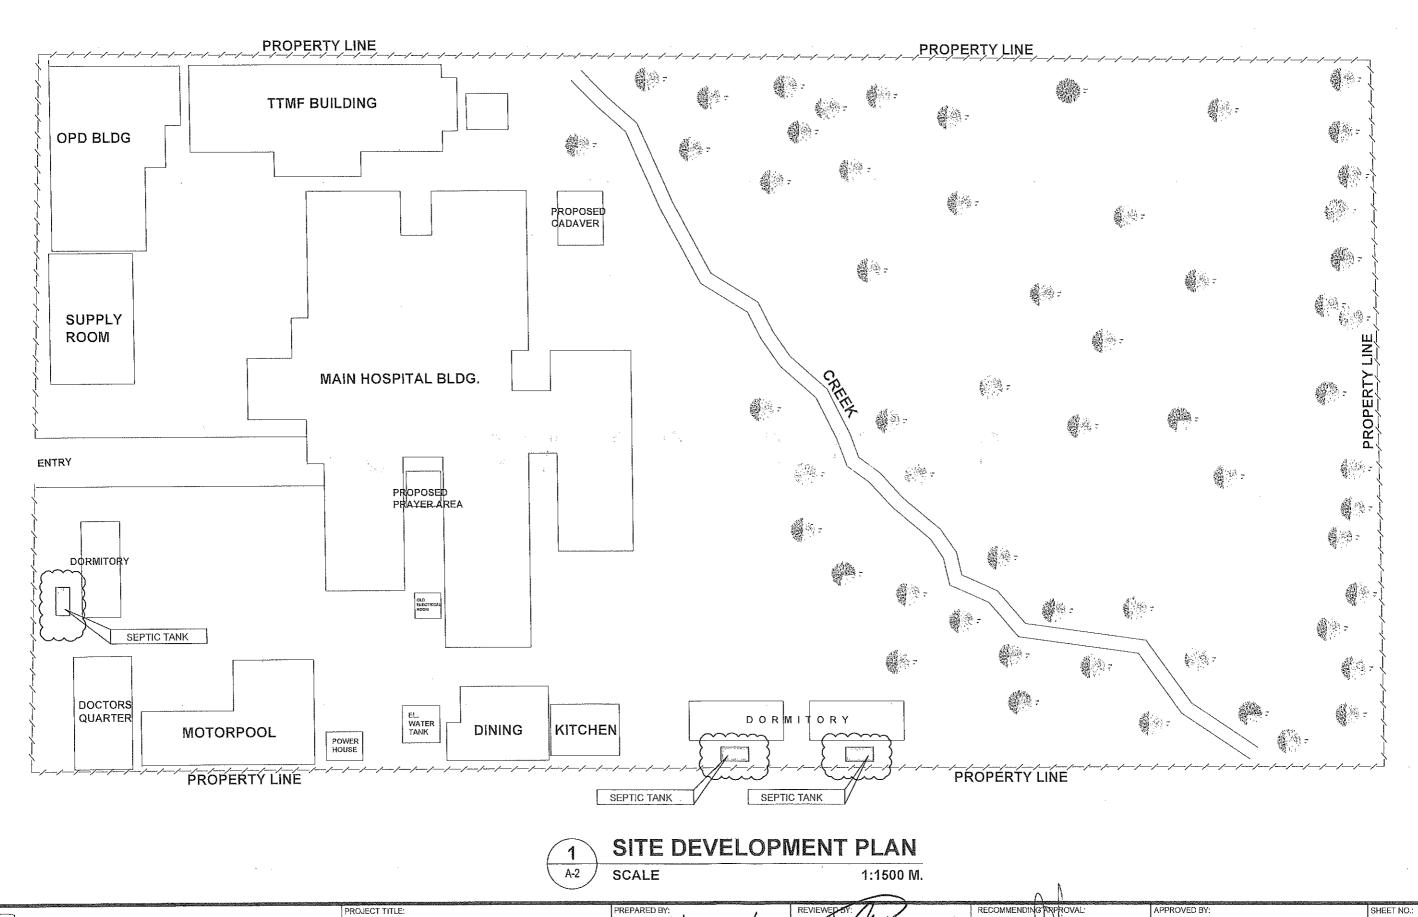




REPUBLIC OF THE PHILIPPINES PROVINCIAL ENGINEER'S OFFICE SAN AGUSTIN, DIGOS CITY, DAVAO DEL SUR

PROJECT TITLE: CONSTRUCTION AND IMPROVEMENT OF GREGORIO MATAS DISTRICT HOSPITAL (GMDH) POBLACION, KIBLAWAN, DAVAO DEL SUR


REXIE GREY B. TABAY

LEONERUMARCH P. SUARIO PROVINCIA ENGINEER

A-2

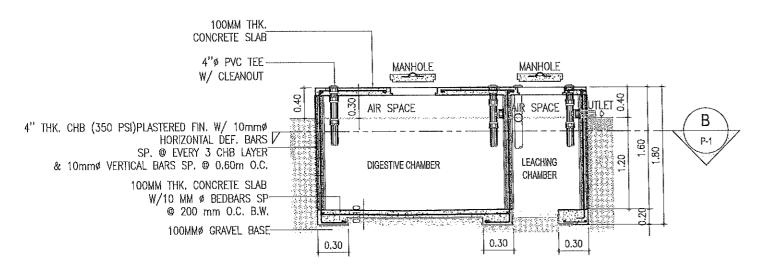

SECTION A-A

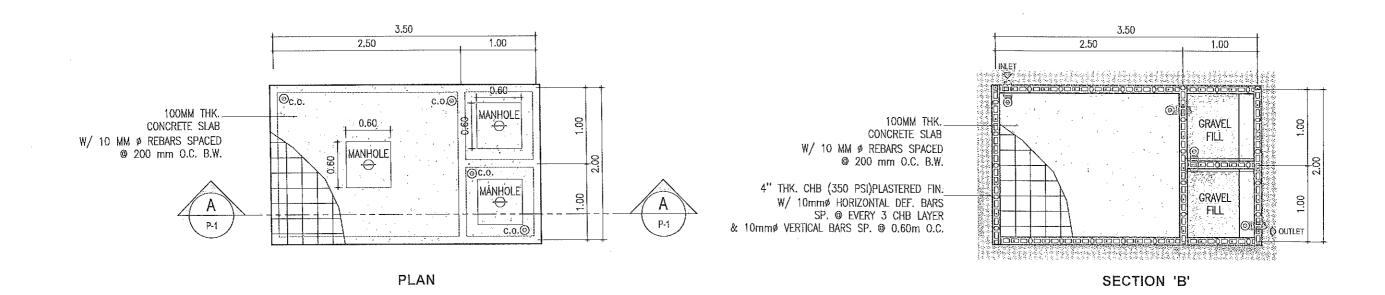

REPUBLIC OF THE PHILIPPINES PROVINCIAL ENGINEER'S OFFICE SAN AGUSTIN, DIGOS CITY, DAVAO DEL SUR

CONSTRUCTION AND IMPROVEMENT OF GREGORIO MATAS DISTRICT HOSPITAL (GMDH) LOCATION:

PREPARED BY: REXIE GREY B. TABAY ARCHITECT III

SEPTIC TANK DETAIL

SCALE

JOSEPH R. GONZALES ENGINEER N ANNING AND PROGRAMING DIV. HEAD LEONERY MARCH P. SUARIO PROVINCIAL ENGINEER

NG APPROVAL:

RECOMMEN

APPROVED BY:


P-1

SHEET NO.:

5 3

POBLACION, KIBLAWAN, DAVAO DEL SUR

1:50 M.

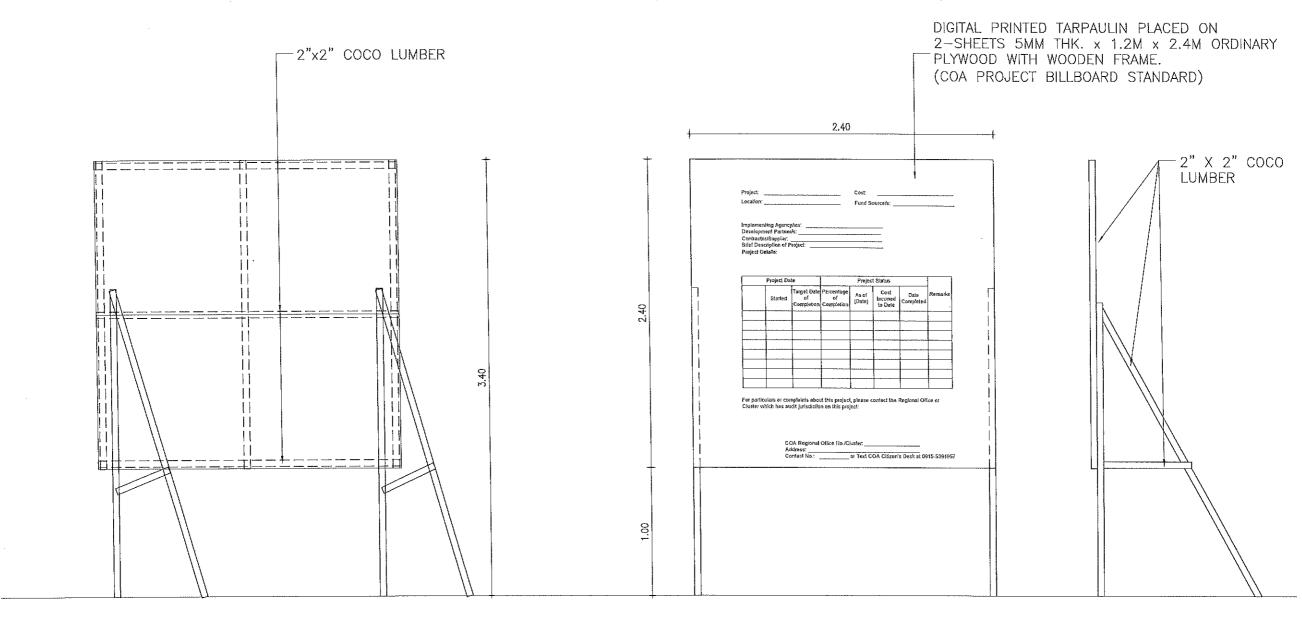

#### PROJECT BILLBOARD DETIAL A1 DRAWN NTS

REPUBLIC OF THE PHILIPPINES
PROVINCIAL ENGINEER'S OFFICE
SAN AGUSTIN, DIGOS CITY, DAVAO DEL SUR

CONSTRUCTION AND IMPROVEMENT OF GREGORIO MATAS DISTRICT HOSPITAL (GMDH)

POBLACION, KIBLAWAN, DAVAO DEL SUR

REXIE GREY B. TABAY

PREPARED BY:

JOSEPH R. GONZALES

ENGINEER III

ANNING AND PROGRAMMING DIV. HEAD

LEONERI MARCH P. SUARIO PROVINCIAL ENGINEER

RECOMMENDING APPROVAL:

VONJE RONY CAGAS
PROVINCIAL GOVERNOR


APPROVED BY:

0-1


4

#### SUMMARY OF QUANTITIES

ITEM NO.	DESCRIPTION	QTY	UNIT
PART B			
B.3	Permits and Clearances	1.00	l.s.
B.5	Project Billboard/Signboard	1.00	each
B.7	Occupational Safety and Health	1.00	l.s.
B.9	Mobilization / Demobilization	1.00	l.s.
	TOTAL OF PART B		
PART C	EARTHWORK		
803(1)a	Structure Excavation, (Common Soil)	39.90	cu.m.
	TOTAL OF PART C		
PART D	REINFORCED CONCRETE		
903(2)	Formworks and Falseworks	21.00	sq.m.
	TOTAL OF PART D		
PART E	FINISHINGS AND OTHER CIVIL WORKS		
1001(11)	Septic Vault	1.00	l.s.
	TOTAL OF PART E		
	GRAND TOTAL		

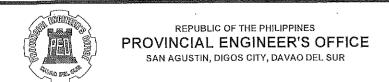

ROJECT TILE:	
	STRUCTION AND IMPROVEMENT OF GORIO MATAS DISTRICT HOSPITAL
OCATION:	(GMDH)
	POBLACION, KIBLAWAN, DAVAO DEL SUR

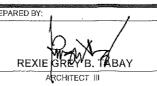



RECOMMENDING APPROVAL:

LEONERU MARCH P. SUARIO
PROVINCIAL ENGINEER

YVONDERONICA

APPROVED BY:

0-2

5

2. CONCRETE ROAD

#### R

#### GENERAL NOTES

#### GENERAL REQUIREMENTS

- 1. THE CONTRACTOR SHALL PROVIDE AND MAINTAIN OFFICES, SHOP, STORES, AND WORKMEN'S ACCOMMODATION AS ARE NECESSARY, A MEDICAL ROOM TOGETHER WITH ALL NECESSARY SUPPLIES SHALL ALSO BE PROVIDED AND MAINTAINED AND A TRAINED MEDICAL AIDE SHALL BE EMPLOYED SOLELY ON MEDICAL DUTIES.
- TWO (2) PROJECT BILLBOARDS SHALL BE INSTALLED, ONE AT THE BEGINNING AND ONE AT THE END OF THE PROJECT, FOR ROAD PROJECTS WITH LENGTH 10 KILOMETER OR MORE, ADDITIONAL SURFACE COURSES BILLBOARD SHALL BE INSTALLED EVERY 5-KILOMETER INTERVAL.
- BASIC PERSONAL PROTECTIVE EQUIPMENT (PPE) FOR ALL CONSTRUCTION WORKERS SHALL BE PROVIDED AND OTHER REQUIRED SPECIALTY PPE AS PER DOLE DO 13 S. 2018, SAFETY PERSONNEL AND EMERGENCY OCCUPATIONAL HEALTH PERSONNEL AND FACILITIES ARE REQUIRED DEPENDING ON THE NUMBER OF WORKERS.
- TRAFFIC MANAGEMENT LAYOUTS PROVIDED IN THE PLAN MAY NOT NECESSARILY BE SIMILAR ON SITE, ADJUSTMENTS MAY BE MADE TO PROVIDE THE NECESSARY TRAFFIC CONTROL DEVICES TO BE INSTALLED ON SITE, A TRAFFIC CONTROLLER MUST ALSO BE PROVIDED ESPECIALLY WHEN CLOSING A CERTAIN LANE OF THE ROAD HINDERS THE CONTINUOUS TRAFFIC FLOW FOR A TWO-WAY
- ADEQUATE BARRICADES AND TRAFFIC WARNING SIGNS SHALL BE INSTALLED AND WORKING AREA SHALL BE ADEQUATELY ILLUMINATED AT NIGHT TO WARN MOTORISTS OF ONGOING CONSTRUCTION, FLAGMEN SHALL BE PROVIDED AT EACH END OF THE CLOSED SECTION TO DIRECT COUNTER FLOW TRAFFIC.
- THE AS-STAKED PLAN SHALL BE PREPARED BY THE CONTRACTOR BASED ON THE PRE-CONSTRUCTION SURVEY JOINTLY CONDUCTED BY THE CONTRACTOR AND IMPLEMENTING DRAINAGE AND SLOPE PROTECTION STRUCTURES OFFICE (CONSTRUCTION AND PLANNING AND PROGRAMMING DIVISION) AND IT SHOULD BE SUBMITTED TO THE PROVINCIAL ENGINEER'S OFFICE BEFORE THE START OF ACTUAL CONSTRUCTION.
- ALL SURVEY, STAKING, RECORDING OF DATA, AND CALCULATION NECESSARY TO CONSTRUCT THE PROJECT FROM THE INITIAL LAYOUT TO FINAL COMPLETION SHALL BE PERFORMED. WORK SHALL BE STARTED AFTER STAKING FOR THE AFFECTED WORK IS ACCEPTED.
- ANY EXISTING ROAD WHILE UNDERGOING IMPROVEMENT SHALL BE KEPT OPEN TO TRAFFIC CONTINUOUSLY IN SATISFACTORY CONDITION AND TRAFFIC SHALL BE ACCOMMODATED DURING THE ENTIRE CONTRACT PERIOD, CONSTRUCTING MAINTAINING DETOURS SHALL BE DONE AS LOCATED BY THE ENGINEER
- DESIGN WAS BASED ON SURVEY DATA SUBMITTED BY THE SURVEY AND INVESTIGATION UNIT OF MISCELLANEOUS STRUCTURES PLANNING AND PROGRAMMING DIVISION OF PEO DAVAO DEL SUR.

#### **EARTHWORK**

- CLEARING SHALL EXTEND ONE (1) METER BEYOND THE TOE OF THE FILL SLOPES OR BEYOND ROUNDING OF CUT SLOPES FOR THE ENTIRE LENGTH OF THE PROJECT PROVIDED THAT IT IS WITHIN THE RIGHT-OF-WAY LIMITS OF THE PROJECT.
- ALL CONCRETE PAVEMENT, BASE COURSE, SIDEWALKS, CURBS, GUTTERS, ETC. DESIGNATED FOR REMOVAL, SHALL BE BROKEN INTO PIECES, THE SIZE OF WHICH SHALL NOT EXCEED 300MM IN ANY DIMENSION AND STOCKPILED AT DESIGNATED LOCATIONS ON THE PROJECT FOR USE BY THE GOVERNMENT OTHERWISE DEMOLISHED AND DISPOSED OF AS DIRECTED BY THE ENGINEER.
- EXCAVATION OPERATION SHALL BE CONDUCTED SO THAT MATERIAL OUTSIDE OF THE LIMITS OF SLOPES WILL NOT BE DISTURBED.
- PRIOR TO CONSTRUCTION OF EMBANKMENT, ALL NECESSARY CLEARING AND GRUBBING IN THAT AREA SHALL HAVE BEEN PERFORMED IN CONFORMITY WITH ITEM 100, CLEARING AND GRUBBING.
- ROADWAY EMBANKMENT OF EARTH MATERIALS SHALL BE PLACED IN HORIZONTAL LAYERS NOT EXCEEDING 200MM, LOOSE MEASUREMENT, AND SHALL BE COMPACTED AS SPECIFIED BEFORE THE NEXT LAYER IS PLACED/ AS COMPACTION OF EACH LAYER PROGRESSES, CONTINUOUS LEVELING AND MANIPULATING WILL BE REQUIRED TO ASSURE UNIFORM DENSITY.
- PRIOR TO FINAL ACCEPTANCE, THE INSPECTOR SHALL VISUALLY INSPECT THE ENTIRE SECTION OF COMPACTED EMBANKMENT. IF FOUND NOT UNIFORM OR THE TEST VALUES MAY NOT BE REPRESENTATIVE OF THE ENTIRE SECTION, ADDITIONAL TESTS MAY BE PERFORMED AND DEFICIENCIES SHALL BE CORRECTED BY THE CONTRACTOR.
- ADEQUATE DUST CONTROL MUST BE MAINTAINED BY THE CONTRACTOR AT ALL TIMES DURING EARTH-MOVING OPERATIONS THROUGH THE USE OF WATIER.
- THE CONTRACTOR SHALL NOT PLACE STOCKPILES AT LOCATION WHERE THEY ARE SUBJECT TO EROSION, THE CONTRACTOR SHALL MAINTAIN EROSION AND DRAINAGE CONTROL NEAR ALL STOCKPILES AND SHALL ENSURE THAT SURFACE DRAINAGE DOES NOT ADVERSELY AFFECT ADJACENT LANDS, WATERCOURSES OR FUTURE RECLAMATION SITES.
- STOCKPILES SHALL NOT BE SITUATED AT LOCATION THAT WILL INTERFERE OR CAUSE DAMAGE TO UTILITIES, IT SHALL NOT BE SITUATED WITHIN 30M OF A WATERCOURSE OR PERMANENT STRUCTURE OR WITHIN 4M OF ADJACENT PROPERTY BOUNDARY UNLESS OTHERWISE PERMITTED IN WRITING BY THE PROPERTY OWNER.
- 10. FINISHED SURFACES IN ALL CASES SHALL CONFORM WITH LINES, GRADES, DIMENSIONS AND ADJUSTMENTS SHOWN ON THE APPROVED PLANS, EXCEPT AS MODIFIED BY WRITTEN ORDERS.
- 11. CUT SLOPES, EXCEPTS IN ROCKS AND FILL SLOPES SHALL BE ADJUSTED AND WARPED FLOW INTO EACH OTHER OR INTO NATURAL GROUND SURFACE WITHOUT NOTICEABLE BREAK.

SUB-BASE AND BASE COURSE

1. FOR SUBBASE MATERIALS, WHERE THE REQUIRED THICKNESS IS 200MM OR LESS, THE MATERIAL SHALL BE SPREAD AND COMPACTED IN ONE (1) LAYER USING VIBRATORY ROLLER EQUIPMENT. WHERE THE REQUIRED THICKNESS IS MORE THAN 200MM, THE AGGREGATE SUBBASE SHALL BE SPREAD AND COMPACTED IN TWO OR MORE LAYERS OF APPROXIMATELY EQUAL THICKNESS, AND THE MAXIMUM COMPACTED THICKNESS OF ANY LAYER SHALL NOT EXCEED 200MM.

- THE CONTRACTOR SHALL TAKE ALL STEPS NECESSARY TO CONTROL TRAFFIC OVER NEWLY-LAID CONCRETE SO THAT THE SURFACE IS NOT DAMAGED IN ANY WAY. TRAFFIC SHALL BE PROHIBITED FROM TRAVELING AT SPEEDS IN EXCESS OF 40KPH UNTIL THE CONCRETE HAS SET. NO VEHICLES, INCLUDING THOSE DELIVERING AGGREGATES SHALL BE PERMITTED TO TURN AROUND ON NEWLY-LAID MATERIAL
- WHEN RAIN APPEARS IMMINENT, ALL PACING OPERATIONS SHALL STOP.
- IN ORDER THAT THE CONCRETE MAY BE PROPERLY PROTECTED AGAINST THE EFFECTS OF RAIN BEFORE THE CONCRETE SUFFICIENTLY HARDENED, THE CONTRACTOR WILL BE REQUIRE TO PROTECT THE EDGES AND SURFACE OF THE UNHARDENED CONCRETE,
- BEFORE OPENING TO THE TRAFFIC, THE PAVEMENT SHALL BE CLEANED AND JOINT SEALING COMPLETED
- ANY DAMAGE TO THE PAVEMENT, OCCURRING PRIOR TO FINAL ACCEPTANCE, SHALL BE REPAIRED OR THE PAVEMENT BE REPLACED.

- PIPE CULVERTS SHALL BE INSPECTED BEFORE ANY BACKFILL IS PLACE. ANY PIPE FOUND TO BE OUT ALIGNMENT, UNDULY SETTLED, OR DAMAGED SHALL BE TAKEN UP AND RELAID OR REPLACED.
- STONES FOR RIPRAP SHALL CONSIST OF ROCK AS NEARLY AS RECTANGULAR IN SECTION EXCEPT THAT RIPRAP OF CLASS A MAY CONSIST OF ROUND NATURAL STONES. SOUND PIECES OF BROKEN CONCRETE OBTAINED FROM THE REMOVAL OF BRIDGES, CULVERTS AND OTHER STRUCTURES MAY BE SUBSTITUTED FOR STONE WITH THE APPROVAL OF THE ENGINEER.
- FOR STONE MASONRY, IT SHALL BE SATISFACTORILY PROTECTED FROM THE SUN AND KEPT WET FOR A PERIOD OF AT LEAST THREE DAYS AFTER COMPLETION.

- 1. OBSTRUCTIONS WITHIN THE ROADWAY, IF NOT ILLUMINATED, SHALL BE MARKED WITH REFLECTORIZED HAZARD MARKERS (REFER TO SECTION 7 OF THE HIGHWAY SAFETY DESIGN STANDARD PART 2 MAY 2012 EDITION). FOR ADDITIONAL EMPHASIS, IT IS ADVISABLE TO MARK OBSTRUCTION WITH NO LESS THAN FIVE ALTERNATING REFLECTORIZED BLACK AND WHITE STRIPES.
- GUARDRAIL POSTS SHALL BE SET VERTICALLY IN THE POSITION SHOWN IN THE PLANS AND SHALL REMAIN UNDISTURBED FOR A MINIMUM OF 48 HOURS.
- RAIL ELEMENTS SHALL BE ERECTED IN A MANNER RESULTING IN A SMOOTH CONTINUOUS INSTALLATION. ALL BOLTS, EXCEPT ADJUSTMENT BOLTS, SHALL BE DRAWN TIGHT.
- PAVEMENT MARKINGS SHALL NOT BE APPLIED DURING RAIN OR WET WEATHER OR WHEN THE AIR IS MISTY, PAINT SHALL NOT BE APPLIED UPON DAMP PAVEMENT SURFACES, OR UPON PAVEMENT WHICH HAS ABSORBED HEAT SUFFICIENT TO CAUSE THE PAINT TO BLISTER AND PRODUCE A POROUS FILM OF PAINT.
- PAVEMENT MARKINGS THAT FAIL TO HAVE UNIFORM, SATISFACTORY APPEARANCE EITHER BY DAY OR NIGHT, SHALL BE CORRECTED BY THE CONTRACTOR AT NO COST TO THE GOVIERNMENT.
- TRAFFIC PAINT OF LANE MARKERS AND TRAFFIC STRIPS SHALL BE APPLIED TO THE PAVEMENT AT THE RATE OF 0.33 L/SQ.M. AND SHALL DRY SUFFICIENTLY TO BE FREE FROM CRACKING IN FROM 15 TO 30 MINUTES. THE AMOUNT OF GLASS BEADS TO BE MIXED WITH THE PAINT SHALL 500 GRAMS PER LITER OF PAINT
- JOINT SEALANT APPLICATION SHALL BE TAKEN CARE OF TO AVOID OVERFILLING OF THE JOINT SPACES, ANY EXCESS MATERIAL SHOULD BE IMMEDIATELY SCRAPED FROM THE PAVEMENT
- ROAD SIGNS SHALL USE REFLECTIVE SHEETING CONSISTING OF SPHERICAL LENS ELEMENTS EMBEDDED WITHIN A TRANSPARENT PLASTIC HAVING A SMOOTH, FLAT SURFACE WITH A PROTECTED PRECOAT ADHESIVE WHICH SHALL BE PRESSURE SENSITIVE FOR MANUAL APPLICATION, OR TACK FREE HEAT ACTIVATED FOR MECHANICAL VACUUM-HEAT APPLICATION
- THE REFLECTIVE BRIGHTNESS VALUES OF THE REFLECTIVE SHEETING AS COMPARED TO MAGNESIUM OXIDE (MGO) SHALL BE AS GIVEN IN TABLE 605-1 OF THE STANDARD SPECIFICATIONS MANUAL OR NOT LESS THAN 90% OF THE GIVEN VALUES WHEN TOTALLY WET BY RAIN.

- BEFORE FINAL ACCEPTANCE, THE RIGHT-OF-WAY, BORROW PITS AND ALL GROUND OCCUPIED BY THE CONTRACTOR SHALL BE CLEANED OF ALL RUBBISH, EXCESS MATERIALS, TEMPORARY STRUCTURES AND EQUIPMENT AND ALL PARTS OF THE WORK SHALL BE LEFT IN A NEAT AND PRESENTABLE CONDITION.
- ANY DEFECTIVE WORK WHETHER THE RESULT OF POOR WORKMANSHIP, USE OF DEFECTIVE MATERIALS, DAMAGE THROUGH CARELESSNESS, OR OF ANY OTHER CAUSE, FOUND PRIOR TO ACCEPTANCE, SHALL BE REMOVED IMMEDIATELY AND REPLACED BY WORK AND MATERIALS WHICH

SHALL CONFORM TO THE SPECIFICATIONS.

DAMAGES TO ANY PORTION OF WORK BEFORE FINAL ACCEPTANCE EXCEPTS DAMAGES DUE TO UNFORESEEABLE CAUSES BEYOND THE CONTROL OF AND WITHOUT FAULT OF NEGLIGENCE BY THE CONTRACTOR SHALL BE RESULT, REPAIRED AND RESTORED.

#### REFERENCES

- 1. REVISED DPWH MANUAL ON HIGHWAY SAFETY DESIGN STANDARD, MAY 2013 EDITION
  - FOR ROAD SAFETY PLANNING AND DESIGN ACTIVITIES AS WELL AS ROAD SAFETY MAINTENANCE ACTIVITIES SUCH AS THE PROPER WAY OF INSTALLATION/APPLYING ROAD SIGNS, ROAD SIGNS, ROAD SAFETY DEVICES AND PAVEMENT MARKINGS.
- 2. LABOR CODE OF THE PHILIPPINES AND ITS IMPLEMENTING RULES AND REGULATIONS DOLE DO NO. 13, S.1998, OCCUPATIONAL SAFETY AND HEALTH STANDARDS AND ITS PROCEDURAL GUIDELINES
  - FOR MONITORING, ENFORCEMENT AND IMPLEMENTATION OF CONSTRUCTION SAFETY
  - DO 56, S.2005
- DPWH DESIGN CRITERIA, GUIDELINES AND STANDARDS, 2015.
- GUIDELINES FOR THE PREPARATION OF COST ESTIMATES FOR TRAFFIC MANAGEMENT AND SAFETY & HEALTH REQUIREMENTS FOR THE CONSTRUCTION AND MAINTENANCE OF ROADS, BRIDGES AND SAFETY & HEALTH REQUIREMENTS FOR THE SCHOOL BUILDING, DO 13, S.2018.

REPUBLIC OF THE PHILIPPINES PROVINCE OF DAVAO DEL SUR PROVINCIAL ENGINEER'S OFFICE SAN AGUSTIN, DIGOS CITY

PROJECT TITLE:

CONSTRUCTION AND IMPROVEMENT OF GREGORIO MATAS DISTRICT HOSPITAL (GMDH)

DONALD A. RELLON MANUS TAYABAS

PH R. GONZALES ENGINEER III
LANNING AND PROGRAMMING DIVISION HEAD RECOMMENDING APPROVAL:


APPROVED BY

SHEET No.: S-1

5

PORLACION XIRI AWAN, DAVAO DEL SUR

LEONER MARCH P. SUARIO PROYINGIAL ENGINEER

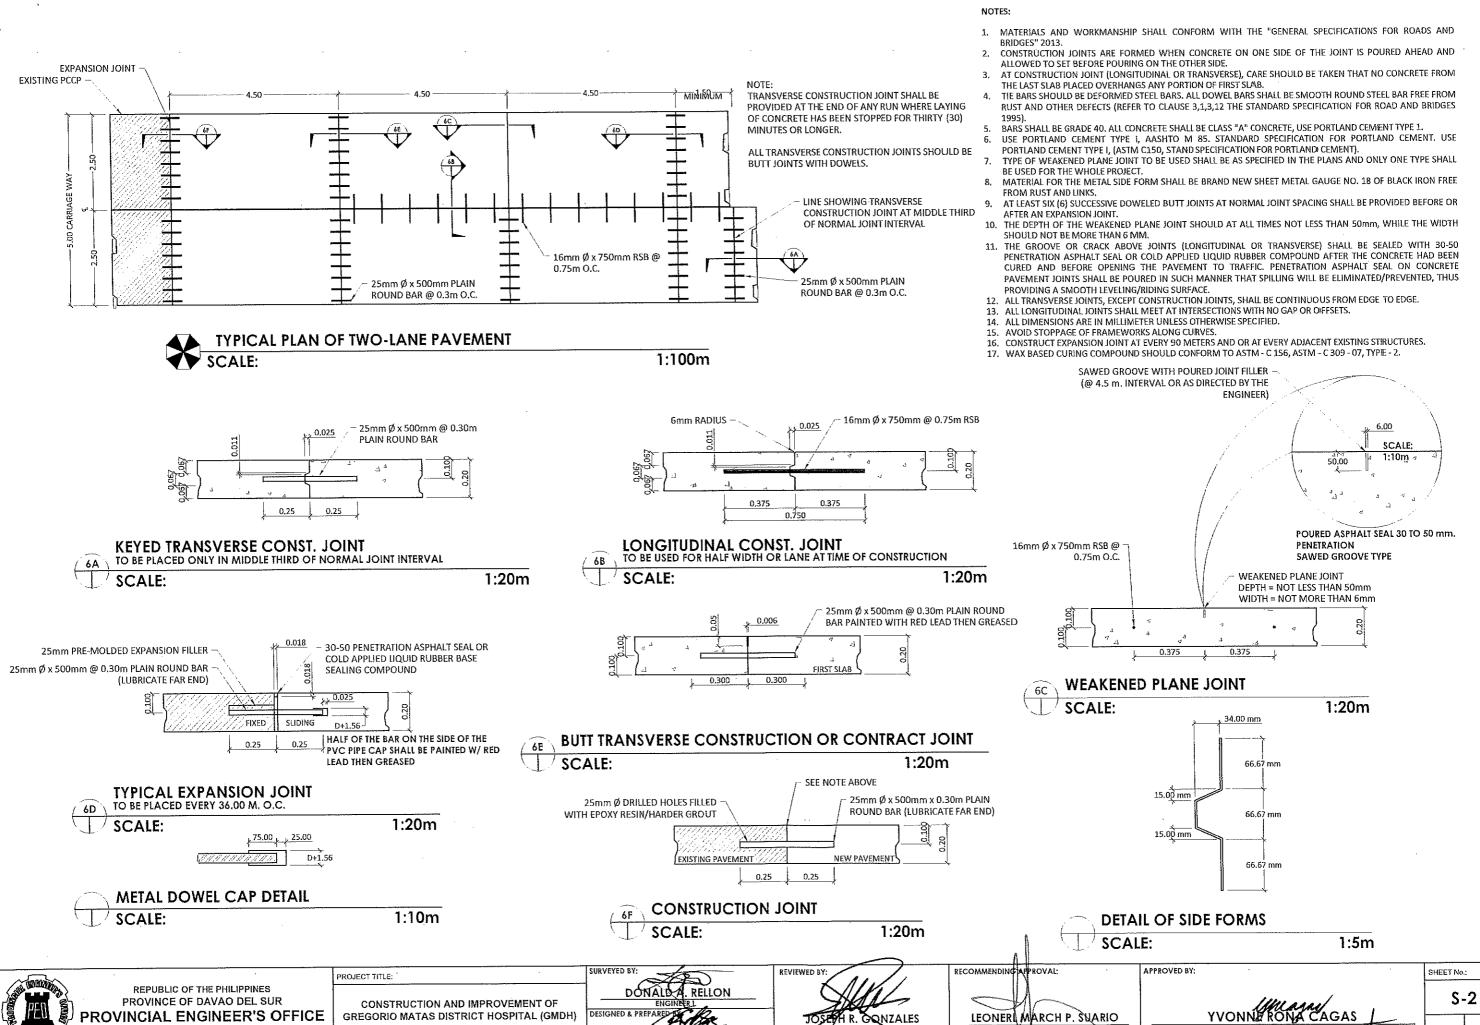

SAN AGUSTIN, DIGOS CITY

POBLACION KIBLAWAN, DAVAO DEL SUR

LOCATION


ENGINEER II PROGRAMM


DIVISION HEAD


PROVINCIAL ENGINEER

5

2

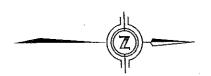

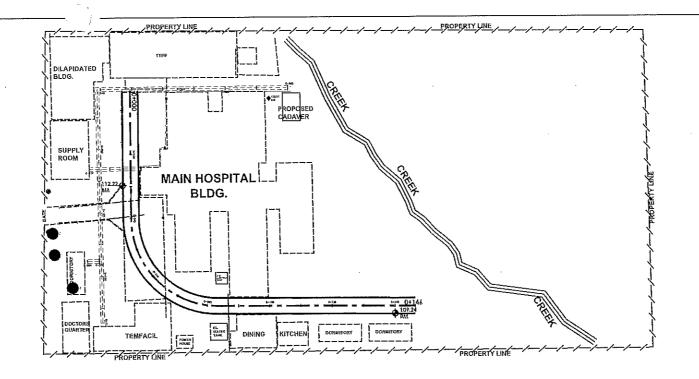

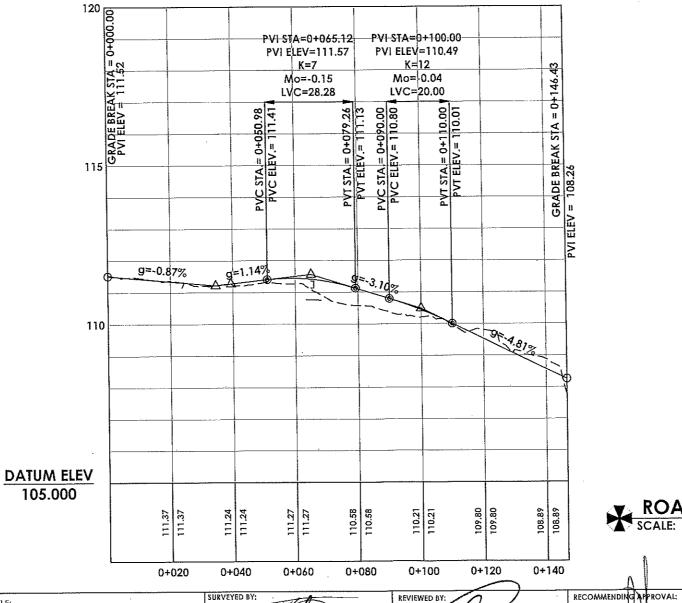

ROADWAY PLAN AND PROFILE
SCALE: 1:1200m

APPROVED BY:



PROJECT TITLE:

LOCATION:


CONSTRUCTION AND IMPROVEMENT OF GREGORIO MATAS DISTRICT HOSPITAL (GMDH)

POBLACION KIBLAWAN, DAVAO DEL SUR

JOSERH R. CONZALES

LEONER MARCH P. SUARIO
PROVINCIAL ENGINEER

SHEET No.: **S-3** 

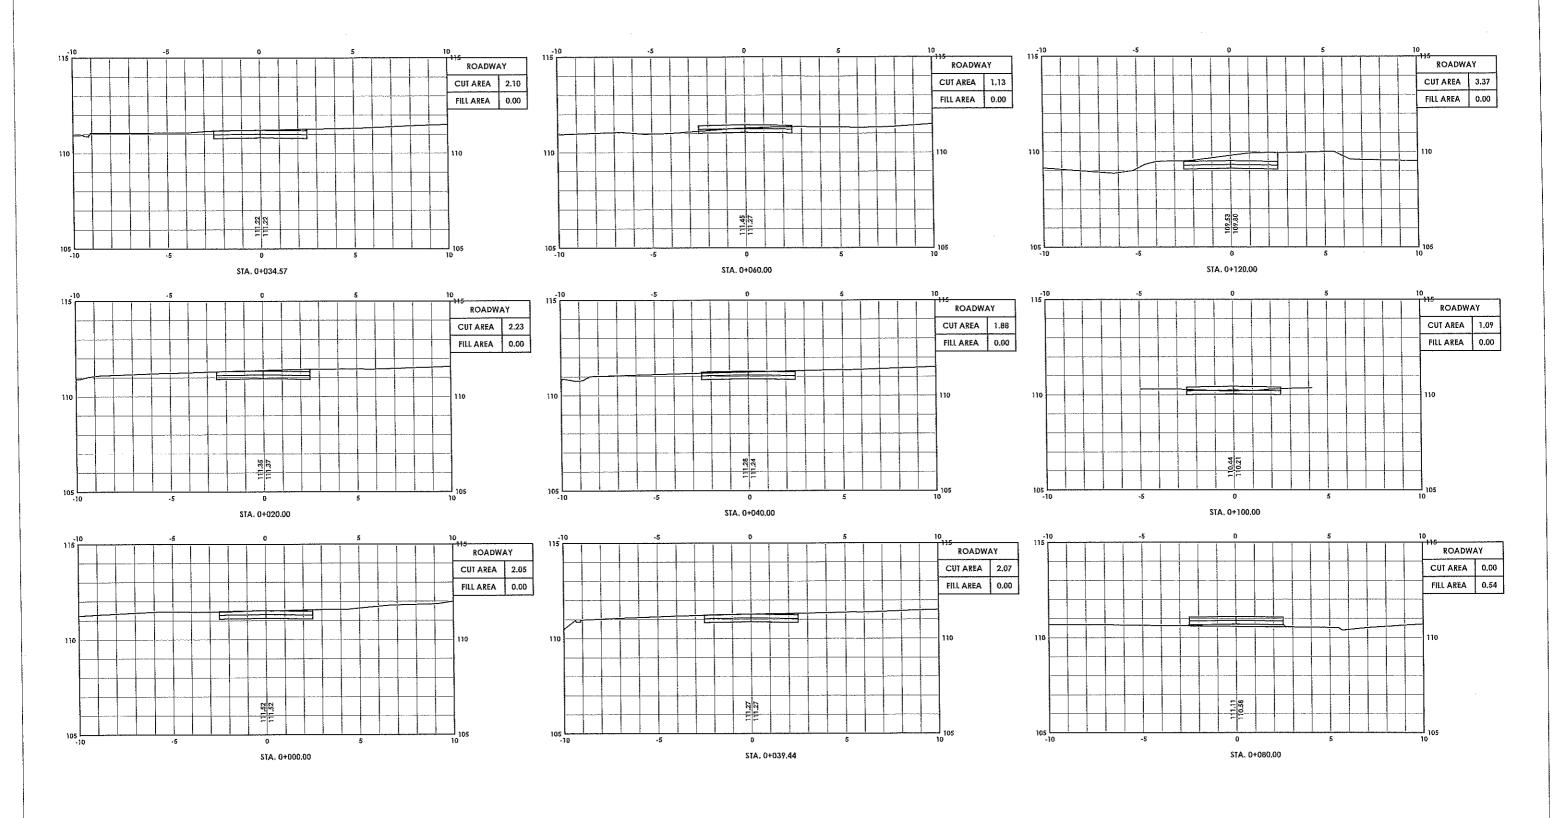

# ROADWAY CROSS SECTIONS SCALE: 1:200m



PROJECT TITLE:

LOCATION:

CONSTRUCTION AND IMPROVEMENT OF GREGORIO MATAS DISTRICT HOSPITAL (GMDH)

POBLACION KIBLAWAN, DAVAO DEL SUR

DONALD A RELLON ENGINEER

REVIEWED BY JOSE HR. CONZALES

RECOMMENDING APPROVAL: LEONERL MARCH P. SUARIO


PROVINCIAL ENGINEER

YVONN RONA CAGAS
PROVINCIAL GOVERNOR


APPROVED BY:

SHEET No.; **S-4** 

5

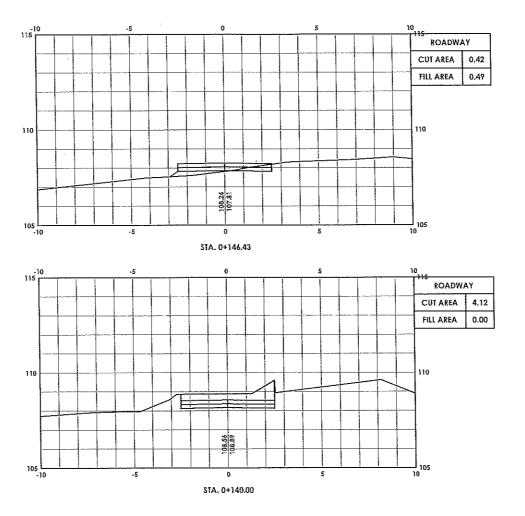



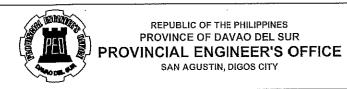

CONSTRUCTION AND IMPROVEMENT OF

GREGORIO MATAS DISTRICT HOSPITAL (GMDH) POBLACION KIBLAWAN, DAVAO DEL SUR


RECOMMENDENC APPROVAL:


LEONER MARCH P. SUARIO PROVINCIAL ENGINEER


APPROVED BY:

SHEET No.: S-5


3. PERIMETER FENCE WITH SOLAR LIGHTS

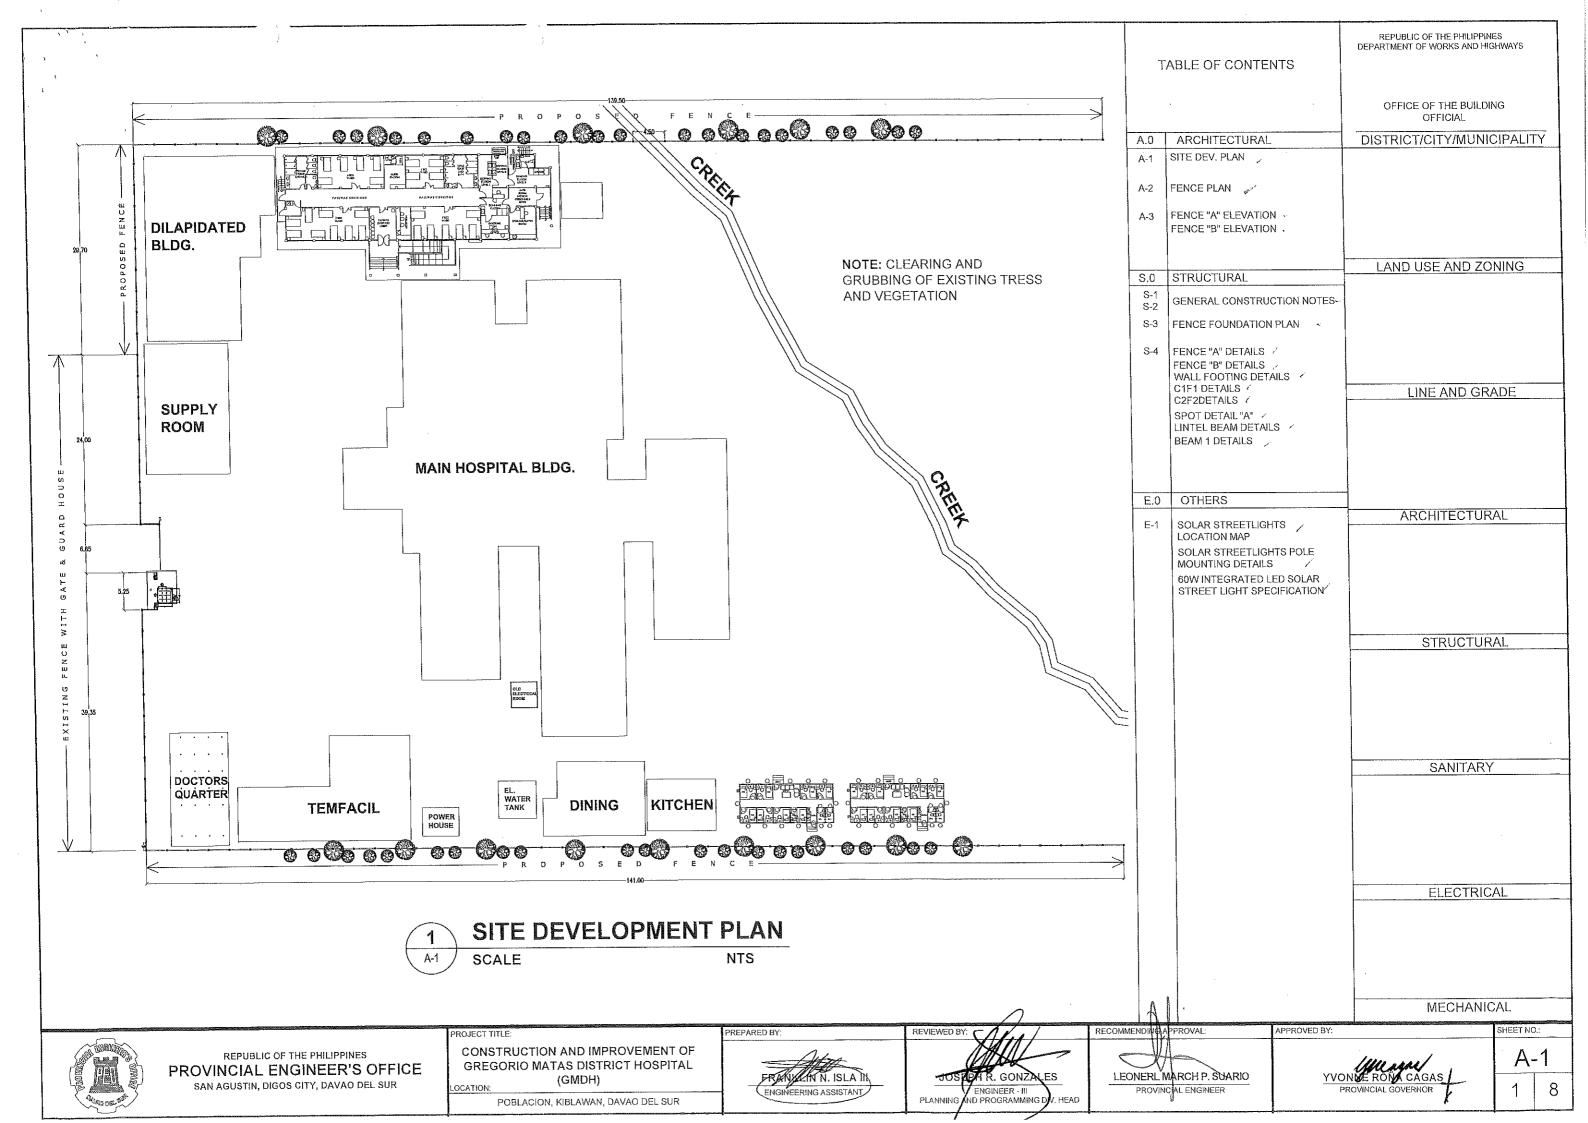

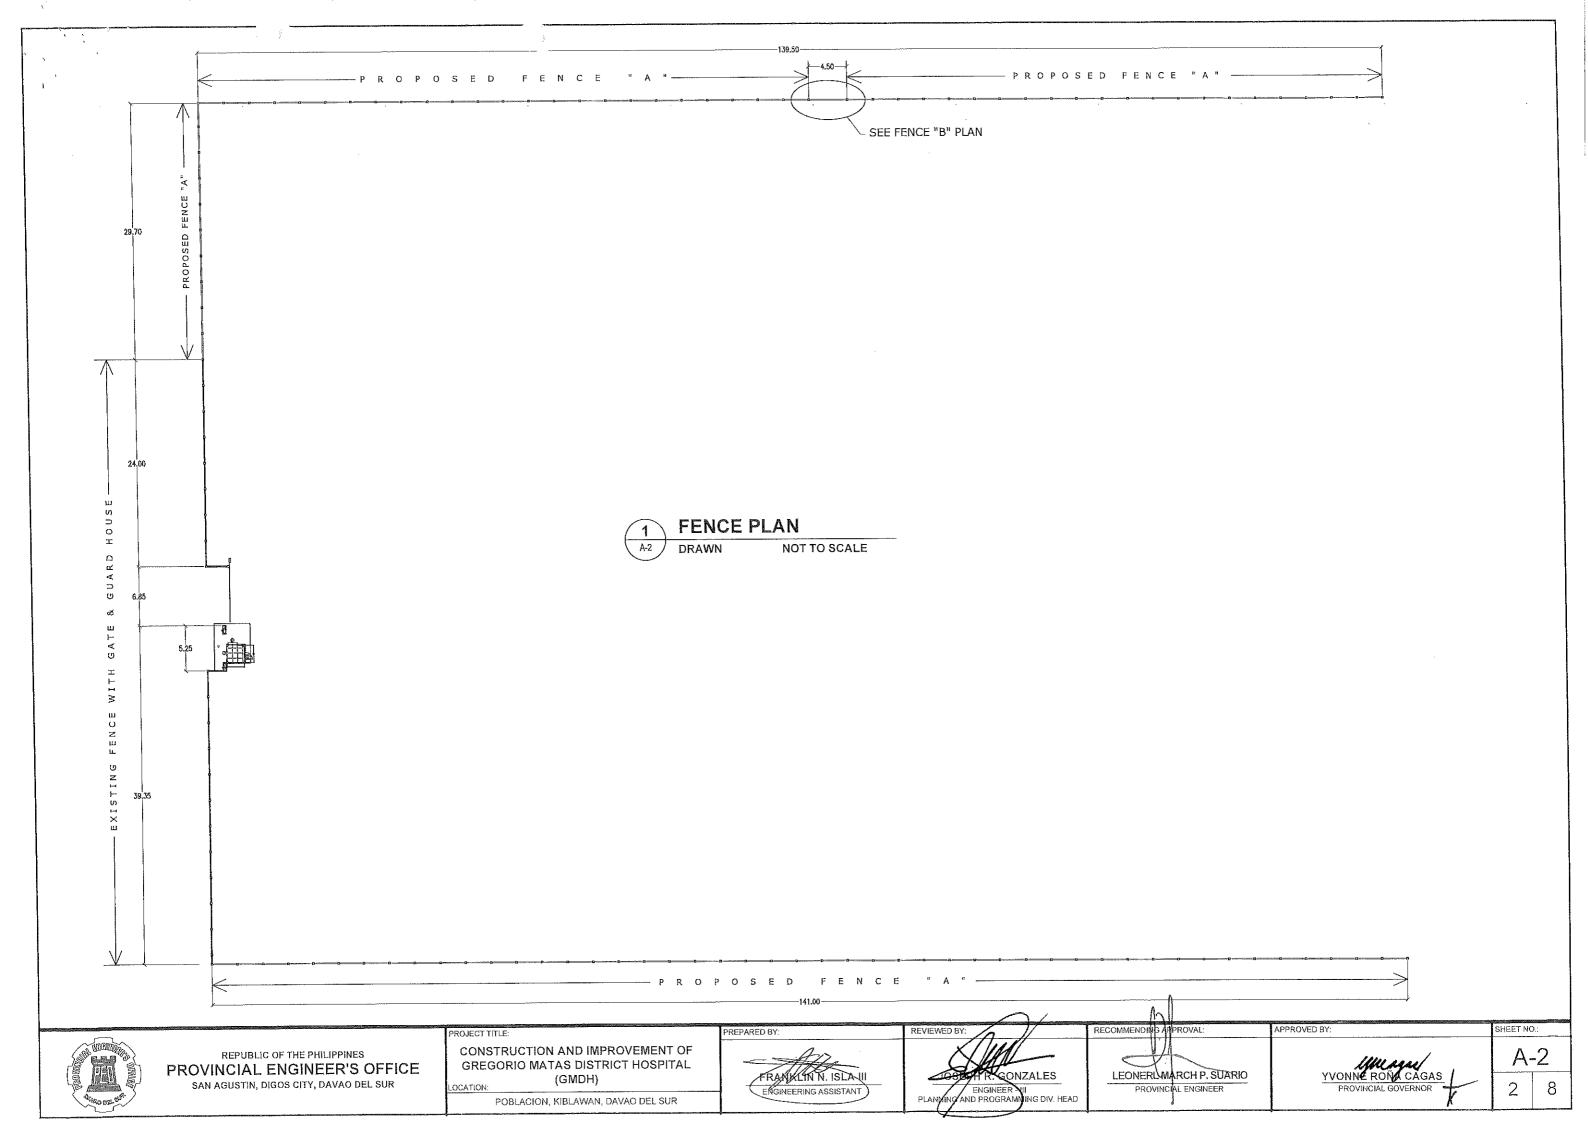

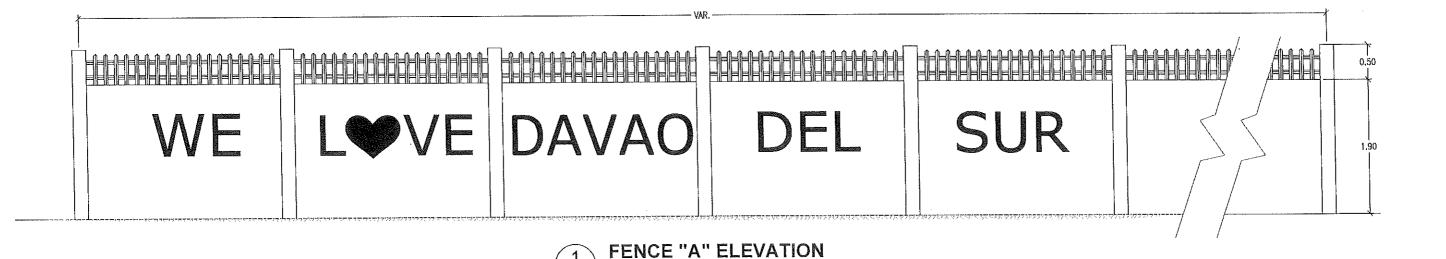

NOT TO SCALE

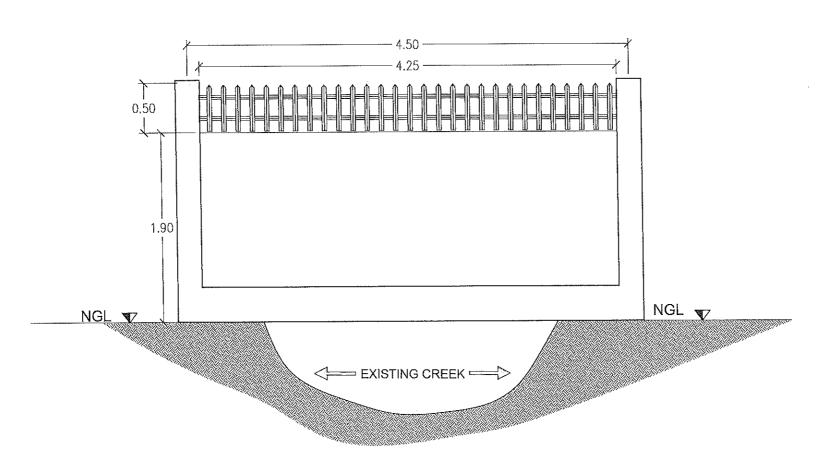



PREPARED BY



CONSTRUCTION AND IMPROVEMENT OF GREGORIO MATAS DISTRICT HOSPITAL (GMDH)

GORIO MATAS DISTRICT HOSPITAL
(GMDH)

POBLACION, KIBLAWAN, DAVAO DEL SUR

ENGINEERING ASSISTA

N. ISLA III
ASSISTANT
PLANNING AND PROGRAMMING DIV

LEONERL MARCH P. SDARIO
PROVINCIAL ENGINEER

YVONNE ROND CAGAS
PROVINCIAL GOVERNOR

APPROVED BY:

A-3

SHEET NO.:

#### GENERAL NOTES

#### 1.0 STANDARDS AND REFERENCES

THE FOLLOWING SHALL GOVERN THE DESIGN FABRICATION AND CONSTRUCTION OF THE PROJECT

1.1 NATIONAL STRUCTURAL CODE OF THE PHILIPPINES (N.S.C.P 2015) VOL. 1, SEVENTH EDITION. 1,2 SPECIFICATIONS SHALL BE IN ACCORDANCE WITH THE DPWH STANDARD SPECIFICATIONS FOR PUBLIC WORKS STRUCTURES VOLUME III, 2019 EDITION.

#### 2.0 DESIGN CRITERIA

#### 2.1 LOADINGS

A. DEAD LOAD

SEA ID EOAD	
CONCRETE	23,56 kN/m³
STEEL	76.93 kN/m <sup>3</sup>
150 mm THK, CHB WALL	2.73 kPa
100 mm THK, CHB WALL	2.11 kPa
LIVE LOAD	
ROOF	1.00 kPa
TOILETS	1.90 k₽a
CORRIDORS ABOVE, STAIRS	3,80 kPa

#### C. WIND LOAD

BUILDING CATEGORY = 1 (ESSENTIAL FACILITIES)

EXPOSURE = D (FLAT, UNOBSTRUCTED AREAS AND WATER SURFACES)

MAXIMUM WIND VELOCITY, V = 340 KPH  $P = qh \quad [(GCpf)-(GCpi)]$ 

(DESIGN WIND PRESSURE)

WHERE: gh = VELOCITY PRESSURE (kPa) GCpf = EXTERNAL PRESSURE COEFFICIENT GCpf = INTERNAL PRESSURE COEFFICIENT

#### D. SEISMIC LOAD

CORRIDORS ON GROUND

(DESIGN BASE SHEAR)

Vmln = 0.11 CalW  $Vmin = \frac{0.80 \text{ ZNVI}}{D} W \text{ (ZONE 4)}$ 

WHERE: W = TOTAL DEAD LOAD T = NATURAL PERIOD = CI (h) WHERE: C = NUMERICAL COEFFICIENT h = BUILDING HEIGHT I = IMPORTANCE FACTOR = 1.50 R = NUMERICAL FACTOR = 8,50 SEISMIC COEFFICIENT CV = 0.44 NV NEAR SOURCE FACTOR (5 km) Nv = 1.6 Na = 1.2

Z = SEISMIC ZONE = 0.40 (ZONE 4)

A. CONCRETE COMPRESSIVE STRENGTH @ 28 DAYS:

S = SOIL TYPE = D

B. REINFORCING STEEL BARS a. FOR BARS 16mm AND GREATER (INTERMEDIATE GRADE DEFORMED BAR)

FOR TRUSSES, BRACINGS, & STRUTS D. PURLINS

COLD FORMED LIGHT E. MASONRY UNIT (CHB)

NON - LOADING BEARING CHB WALLS

G. STRUCTURAL BOLTS ASTM- A307

a. FOOTINGS, COLUMNS, BEAMS AND SLABS

fc = 20.7 MPa (3,000 psi fc = 17.5 MPa (2,500 psl

fy = 275 MPa (40,000 psi) fy = 230 MPa (33,000 psi) b. FOR BARS LESS THAN 16mm (STRUCTURAL GRADE DEFORMED BAR) C. STRUCTURAL STEEL ASTM-A36 ty = 248 MPa (36,000 psl)

fy = 248 MPa (36,000 psl)

fm1 = 3,45 MPa (500 psl) E - 60XX ELECTRODE a. Fl = 96.60 mPa (14, 000 psi) b. Fv= 69.00 mPa (10, 000 psi)

3.0 IN THE INTERPRETATION OF THE DRAWING, INDICATED DIMENSIONS SHALL GOVERN. DISTANCES AND SIZES SHALL NOT BE SCALED FOR CONSTRUCTIONS PURPOSES

4.0 IN REFERENCES TO OTHER DRAWINGS, SEE ARCHITECTURAL DRAWINGS FOR DEPRESSIONS IN FLOOR SLABS, OPENINGS IN THE WALLS AND SLABS, INTERIOR PARTITIONS, LOCATIONS OF DRAINS ETC.

5.0 IN CASE OF DISCREPANCIES AS TO THE LAYOUT, DIMENSIONS AND ELEVATIONS BETWEEN THE STRUCTURAL PLANS AND ARCHITECTURAL DRAWINGS, THE CONTRACTORS SHALL NOTIFY BOTH THE

6.0 ALL CONCRETE WORKS AND CONCRETE REINFORCEMENTS SHALL BE DONE IN ACCORDANCE WITH THE ACI.318 95 BUILDING CODE REQUIREMENT AND ALL STRUCTURAL STEEL WORKS ACCORDING WITH THE AISC SPECIFICATION (9TH EDITION) SO FAR AS THEY DO NOT CONFLICT WITH THE LOCAL BUILDING CODE REQUIREMENT.

7.0 ACI REFERS TO AMERICAN CONCRETE INSTITUTE, AISC REFERS TO AMERICAN INSTITUTE OF STEEL CONSTRUCTION AND ASTM REFERS TO AMERICAN SOCIETY FOR TESTING MATERIALS.

8.0 CONSTRUCTION NOTES AND TYPICAL DETAILS APPLY TO ALL DRAWINGS UNLESS OTHERWISE SHOWN OR NOTED, MODIFY TYPICAL DETAILS AS DIRECTED TO MEET SPECIAL CONDITIONS.

9.0 SHOP DRAWING WITH ERECTION AND PLACING DIAGRAMS OF ALL STRUCTURAL STEELS, MISCELLANEOUS IRON, PRE-CAST CONCRETE, ETC. SHALL BE SUBMITTED FOR ENGINEERS APPROVAL BEFORE FABRICATION.

10. CONTRACTOR SHALL NOTE AND PROVIDE ALL MISCELLANEOUS CURBS, SILLS , STOOLS EQUIPMENT AND MECHANICAL BASES THAT ARE REQUIRED BY THE ARCHITECTURAL, ELECTRICAL AND MECHANICAL DRAWINGS.

11. ALL RESULTS OF THE MATERIAL TESTING FOR CONCRETE, REINFORCING BARS & STRUCTURAL STEEL MUST BE NOTED & APPROVED BY THE MATERIALS ENGINEER/STRUCTURAL DESIGNER.

# GENERAL CONSTRUCTION NOTES

WHERE CONCRETE IS DEPOSITED

1, USE TYPE 1 PORTLAND CEMENT FOR STRUCTURAL CONCRETE

2, ALL CONCRETE SHALL DEVELOP A MIN. COMPRESSIVE STRENGTH AT THE END OF TWENTY EIGHT (28) DAYS WI CORRESPONDING MAXIMUM SIZE AGGREGATE & SLUMP AS FOLLOWS.

MAX. SIZE OF

LOCATION	28 DAYS STRENGTH	AGGREGATE	MAX SLUM
ALL OTHERS, INCLUDING	3000 PSI (20,7 MPa)	20 mm	100mm
SUSPENDED SLABS COLUMNS BEAMS ,SLABS SLAB ON FILL	3000 PSI (20.7 MPa) 3000 PSI (20.7 MPa) 2500 PSI (17.5 MPa)	20 mm 20 mm 20 mm	100mm 100mm 100mm
			•

3, MAINTAIN MINIMUM CONCRETE COVER FOR REINFORCING STEEL AS FOLLOWS SUSPENDED SLABS SLAB ON GRADE 25mm WALLS ABOVE THE GRADE BEAM STIRRUPS AND COLUMN TIES WHERE CONCRETE IS EXPOSED TO EARTH BUT POURED AGAINST FORMS

4. CONCRETE SHALL BE DEPOSITED IN ITS FINAL POSITION WITHOUT SEGREGATION. RE-HANDLING OR PLACING SHALL BE DONE PREFERABLY WITH BUGGIES, BUCKETS OR WHEELBARROWS, NO CHUTES WILL BE ALLOWED EXCEPT TO TRANSFER CONCRETE FROM HOPPERS TO BUGGIES, WHEELBARROWS OR BUCKETS IN WHICH CASE THEY SHALL NOT EXCEED SIX (6) METERS

5. NO DEPOSITING OF CONCRETE SHALL BE ALLOWED WITHOUT THE USE OF VIBRATORS UNLESS AUTHORIZED IN WRITING DESIGNER AND ONLY FOR UNUSUAL CONDITIONS WHERE VIBRATIONS ARE EXTREMELY DIFFICULT TO ACCOMPLISH.

6, ALL ANCHOR BOLTS, DOWELS, AND OTHER INSERTS SHALL BE PROPERLY POSITIONED & SECURED IN PLACE PRIOR TO PLACING OF CONCRETE.

7. ALL CONCRETE SHALL BE KEPT MOST FOR A MINIMUM OF SEVEN CONSECUTIVE DAYS IMMEDIATELY AFTER POURING BY THE USE O WET BURLAP, FOG SPRAYING, CURING COMPOUNDS OR OTHER

8. STRIPPING OF FORMS AND SHORES: SUSPENDED SLAB EXCEPT WHEN ADDITIONAL LOADS ARE IMPOSED 8 DAYS \_14 DAYS BEAMS

9, THE CONTRACTOR SHALL SUBMIT THE SCHEDULE OF POURING AND THE LOCATION OF THE CONSTRUCTION JOINTS TO THE STRUCTURAL ENGINEER AT LEAST (4) DAYS PRIOR TO THE

10. THE CONTRACTOR SHALL FURNISH AND MAINTAIN ADEQUATE FORMS AND SHORINGS UNTIL THE CONCRETE MEMBERS HAVE ATTAINED THEIR WORKING CONDITION AND STRENGTH.

#### NOTES ON FOOTINGS

1, FOOTINGS ARE DESIGNED FOR AN ALLOWANCE SOIL BEARING PRESSURE OF 96 KPa (2000psf) CONTRACTOR SHALL REPORT TO THE ENGINEER, IN WRITING ,THE ACTUAL SOIL CONDITIONS LINCOVERED AND CONFIRM ACTUAL BEARING CAPACITY OF SOIL BEFORE DEPOSITING CONCRETE

2, FOOTING SHALL REST AT LEAST 1500mm BELOW NATURAL GRADE LINE UNLESS OTHERWISE INDICATED IN PLANS. NO FOOTING SHALL REST ON FILL

3. MINIMUM CONCRETE PROTECTION FOR REINFORCEMENT SHALL BE 75mm CLEAR FOR CONCRETE DEPOSITED THE GROUND AND 50mm FOR CONCRETE DEPOSITED AGAINST A FORMWORK 4. IN CASES WHERE THE SOIL CONDITION IS SUCH THAT THE MINIMUM ALLOWABLE SOIL PRESSURE OF 96KPa (2000 psf) CAN NOT BE ATTAINED AT A PRACTICAL DEPTHS THE USE OF MICROPILES .

BORED PILES, OR DRIVEN PILES MAY BE ADOPTED IN LIEU OF STANDARD ISOLATED FOOTINGS

#### NOTES ON REINFORCEMENT


1. UNLESS OTHERWISE NOTED IN PLANS, THE YIELD STRENGTH OF REINFORCING BARS SHALL BE: A. FOOTINGS , FOOTING BEAMS AND GIRDERS \_\_\_\_ fv = 275 MPa (40 000 ns)  $f_V = 275 \text{ MPa} (40,000 \text{ psl})$ C. BEAMS AND GIRDER

 $_{-}$  fy = 275 MPa (40.000 ps) 2. ALL REINFORCING BARS SIZE 10mm OR LARGER SHALL BE DEFORMED IN ACCORDANCE WITH THE ASTM A-706

BARS SMALLER THAN 10mm MAY BE PLAIN. 3. SPLICES SHALL BE SECURELY WIRED TOGETHER & SHALL LAP OR EXTEND IN ACCORDANCE W/ TABLE B (TABLE OF LAP SPLICE & ANCHORAGE LENGTH) UNLESS OTHERWISE SHOWN ON DRAWINGS , SPLICES SHALL BE STAGGERED WHENEVER POSSIBLE.

#### NOTES ON CONCRETE SLABS

1. ALL SLAB REINFORCEMENTS SHALL BE 20min CLEAR MINIMUM FROM BOTTOM AND FROM THE TOP OF SLAB 2, UNLESS OTHERWISE SHOWN, REINFORCEMENT IN CONTINUOUS ELEVATED SLAB SHALL BE CUT AS FOLLOWS:

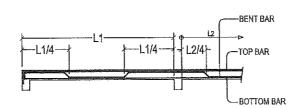


BELOW THOSE ALONE THE LONG SPAN AT THE CENTER AND OVER THE LONGER SPAN FOR REINFORCING BARS NEAR THE SUPPORTS. THE SPACING OF THE BARS AT THE COLUMN STRIPS SHALL NOT BE MORE THAN ONE AND A HALF ( 1 J) SLAB THICKNESS.

4. TEMPERATURE BARS FOR SLAB SHALL BE GENERALLY PLACED NEAR THE FACE IN TENSION AND SHALL NOT BE LESS THAN 0.0025 X GROSS-SECTIONAL AREA (Ag) OF THE SLAB. ( SEE SCHEDULE BELOW)


SCHEDUL	e of Minimum	SLAB REINFORCEMENT			
MINIMUM TEMPERATURE BARS					
100 mm	10mm Ø	@ 250mm EACH WAY			
125 mm	10mm Ø	@ 250mm EACH WAY			
150 mm	10mm Ø	@ 250mm EACH WAY			
175 mm	10mm Ø	@ 250mm EACH WAY			
200 mm	10mm Ø	@ 250mm EACH WAY			

- 5, UNLESS OTHERWISE NOTED IN THE PLANS ALL BEDDED SLABS SHALL BE REINFORCED WITH 10mm Ø AT 250mm O.C. EACH WAY TO CENTER OF SLAB AND CONSTRUCTION JOINTS FOR SAME SHALL
- 6. PROVIDE EXTRA REINFORCEMENTS FOR CORNER SLAB (TWO ADJACENT DISCONTINUES EDGES) AS SHOWN BELOW.
- 7. CONCRETE SLAB REINFORCEMENT BE PROPERLY SUPPORTED WITH 10mm STEEL CHAIR OR APPROVED EQUIVALENT SPACED AT 1.0 METER ON CENTER BOTHWAYS.

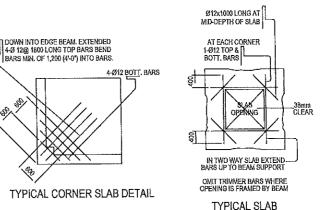


## NOTES ON COLUMNS

- 1. PROVIDE EXTRA SETS OF TIES AT 100 O.C. FOR TIED COLUMN REINFORCEMENT ABOVE AND BELOW BEAM-COLUMN CONNECTIONS FOR A DISTANCE FROM FACE OF CONNECTION EQUAL TO GREATER OF THE OVERALL THICKNESS OF COLUMN, 1/6 THE CLEAR HEIGHT OF COLUMN OR 450mm.
- 2. COLUMN TIES SHALL BE PROTECTED EVERYWHERE BY A COVERING OF CONCRETE CAST MONOLITHICALLY WIT THE CORE WITH A MINIMUM THICKNESS OF 40mm AND NOT LESS THAN 40 TIMES THE MAXIMUM SIZE OF COARSE AGGREGATE IN MILLIMETERS.
- 3. WHERE COLUMNS CHANGE IN SIZE VERTICAL REINFORCEMENT SHALL BE OFFSET AT A SLOPE MONOLITHICALLY WITH THE CORE WITH MINIMUM THICKNESS OF 40mm AND NOT LESS THAN 40 TIMES THE MAXIMUM SIZE COARSE AGGREGATE IN MILLIMETERS
- 4, UNLESS OTHERWISE INDICATED IN THE PLANS, LAP SPLICES FOR VERTICAL COLUMN REINFORCEMENT SHALL BE MADE WITHIN THE CENTER HALF OF COLUMN HEIGHT, AND THE SPLICE LENGTH SHALL BE LESS THAN 40 BAR DIAMETERS. WELDING OR APPROVED MECHANICAL DEVICES MAY BE USED PROVIDED THAT NOT MORE THAN ALTERNATE BARS ARE WELDED OR MECHANICALLY SPLICED AT ANY LEVEL AND THE VERTICAL DISTANCES BETWEEN THESE WELDS OR SPLICES OF ADJACENT BARS IS NOT LESS THAN 600mm.

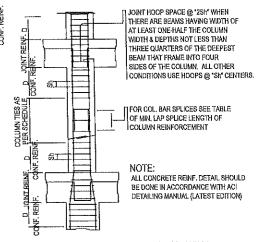


TYPICAL COLUMN ELEV. SHOWING DOWELS AND TIES SPACING

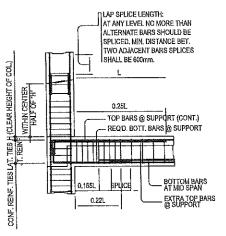

TYP. DETAIL OF COL. LAP SPLICE & EXT. GIRDER TO COL, CONNECT

### NOTES ON BEAMS AND GIRDERS

- 1. UNLESS, OTHERWISE NOTED IN PLANS , CAMBER ALL BEAMS AND GIRDER AT LEAST 8mmØ FOR EVERY 4.50 M OF SPAN , EXCEPT CANTILEVERS FOR WHICH THE CAMBER SHALL BE AS NOTED IN PLANS OR AS ORDERED BY THE ENGINEER BUT IN NO CASE LESS THAN 20 mm FOR EVERY 3.0 M OF FREE SPAN.
- 2. TYPICAL BARS BENDING AND CUTTING DETAILS FOR BEAMS SHALL BE AS SHOWN IN FIG. B-1

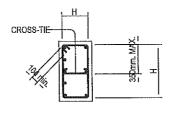

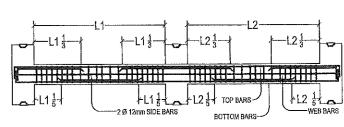


FIGURE B-1



REPUBLIC OF THE PHILIPPINES PROVINCIAL ENGINEER'S OFFICE

SAN AGUSTIN, DIGOS CITY, DAVAO DEL SUR

CONSTRUCTION AND IMPROVEMENT OF GREGORIO MATAS DISTRICT HOSPITAL (GMDH)

POBLACION, KIBLAWAN, DAVAO DEL SUR

FRANKLIN N. ISDA III ENGINEERING ASSISTANT

PREPARED B

H R/ GONZ ENSINEER - III

LEONER MARCH P. SUARIO PROVINCIAL ENGINEER

RECOMMENDINGNPPROVAL

PPROVED BY

HEET NO.


## GENERAL CONSTRUCTION NOTES

#### TABLE 'A' TENSION BARS TABLE OF LAP SPLICE & ANCHORAGE LENGTH (mm) fc'= 20.7MPa(30XXpsi) fc'= 27.6 MPa (4000psi) BAR SIZES Ø12 400 220 400 550 350 500 Ø25 500 800 550 760 1000 650 850 Ø28 750


OTES:				
	MIDARD MITTO	II NEVIAL DIETE	v n	
	UN BARS, MULTIS			
2. ROT NO	RE THAN 33% OF	THE BARS S	SHALL BE	
SOLICI	FO WATERN TO JE TO	Entibent &	PIFNOT	ŧ

TABLE		PRESSION B E & ANCHO	ARS RAGE LENGTH (	mm)
BAR SIZES	fc'= 20.7M	Pa(300psi)	fc'= 27.6 MPs	(4000psl)
(DEFORMED IVIII)	EMBEDMENT	LAPPED	EMBEDMENT	LAPPED
Ø10	225	300	200	300
Ø12	275	300	250	300
Ø16	350	400	325	400
Ø20	450	600	475	500
Ø25	550	625	650	625
028	625	875	625	676
Ø32	700	776	700	775

- 3. IF THE BEAM REINFORCING BARS END IN A WALL, THE CLEAR DISTANCE FROM THE BAR TO THE FARTHER FACE OF THE WALL IS NOT LESS THAN 25mm. EMBEDMENT LENGTH SHALL BE SHOWN IN TABLE 'A' FOR TENSION BARS AND TABLE 'B' FOR COMPRESSION BARS UNLESS SPECIFIED IN PLAN. TOP BARS SHALL NOT BE SPLICED WITHIN THE COLUMN OR TWO STIRRUPS SHALL BE PROVED AT ALL SPLICES.
- 4, IF THERE ARE TWO OR MORE LAYERS OF REINFORCING BARS, USE 25mm BAR SEPARATORS SPACED AT 1.0M ON CENTER IN NO CASE SHALL THERE BE THAN TWO (2) SEPARATORS BETWEEN LAYERS OF BARS
- 5. MINIMUM CONCRETE PROTECTION FOR REINFORCING BARS OR STEEL SHAPES SHALL BE AS SHOWN IN FIGURE B-2 UNLESS ELSEWHERE

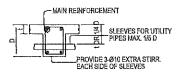

TYP, DET. FOR SLEEVES THRU CONCRETE BEAM FIG. B-2

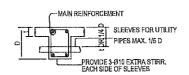

TYP, DET. FOR SLEEVES THRU CONCRETE BEAM FIG. B-3

- 6. WHEN A BEAM CROSSES A GIRDER, REST BEAM ON TOP OF GIRDER BARS, BEAM REINFORCING BARS SHALL BE SYMMETRICAL ABOUT THE CENTER LINE WHENEVER POSSIBLE.
- 7. GENERALLY, NO SPLICES SHALL BE PERMITTED AT POINTS WHERE CRITICAL BENDING STRESSES OCCUR, SPLICES WHERE SO PERMITTED SHALL BE INDICATED IN TABLE 'A' AND 'B'. WELDED SPLICES SHALL DEVELOP IN TENSION AT LEAST 125% OF THE SPLICED YIELD STRENGTH OF THE BAR NOT MORE THAN 50% OF THE BARS AT ANY ONE SECTION IS ALLOWED TO BE SPLICED THEREIN.


#### NOTES ON CONCRETE HOLLOW BLOCKS WALLS


- 1. UNLESS OTHERWISE SHOWN IN PLANS ALL CONCRETE HOLLOW BLOCKS AND CERAMIC BLOCKS SHALL BE REINFORCED AS SHOWN IN THE SCHEDULE OF CONCRETE HOLLOW BLOCKS AND CERAMIC BLOCK REINFORCEMENT.
- 2, PROVIDE 150mm x 300mm STIFFENER COLUMN REINFORCED WITH 4-12mm WITH 10mm Ø TIES AT 150mm ON CENTER WHERE CONCRETE HOLLOW BLOCK TERMINATES AND AT EVERY 3,0M LENGTH OF CONCRETE HOLLOW BLOCK WALLS UNLESS NOTED IN STRUCTURAL PLANS.


NO	TES ON CONCRETE H	OLLOW BLOCKS W	ALLS REINFORCEMENTS
BLOCK THICKNESS	REINFORCE	MENT	NOTES
	HORIZONTAL	LAPPED	A. MINIMUM LAPS AT SPLICE= 0,25 M
75 mm	10mm Ø EVERY 3RD LEVEL	10mm Ø @ 600mm O.C.	B. PROVIDE RIGHT ANGLED REINFORCEMENT AT CORNERS 0.92 m LONG
125 mm	10mm Ø EVERY 3RD LEVEL	10mm Ø @ 600mm O.C.	
150mm	10mm Ø EVERY 3RD LEVEL	10mm Ø @ 600mm O.C.	C.WHERE CHB OR CER. BLK. WALL DOWELS WITH THE SAME SIZE AS VER. OR HOR. REINFORCEMENT SHALL BE PROVIDED
200 mm	12mm Ø EVERY 3RD LEVEL	10mm Ø @ 600mm O.C.	ACINFORGEMENT GLACE BE TAGNIBLE

#### REINFORCING CONCRETE LINTEL BEAMS IN CONCRETE BLOCK WALLS

	LI	NTEL	S IN B	LOCK '	WALLS	3
CLEAR	TOTAL LENGTH	MIN.	HEIGHT OF	F	REINFOR	RCEMENT
SPAN (L)	(L+0,40M)	(MPa)	(mm)	воттом	TOP	STIRRUPS
1.20 M	1.60 K		200	1-810	1-2510	Ø8 (ncn @ 200mm
1.50 M	1.90 14	14.0	200	1-510	1-2010	996 mm @ 200mm
1.89 M	2.20 M		200	1-012	1-810	658 pm, @ 200mm
2.10 M	250 M		250	1-2512	1-Ø10	(26 iran) @ 200mm
2.40 M	2.90 M	17.0	250	1-Ø12	1-610	98 mm @ 200am
2.70 M	3.10 M		250	1-2716	1-Ø12	Ø10mzni @ 200mm
3.50 M	3.40 M		300	1-Ø18	1-Ø12	Ø10πtπ @ 200km/n
3.30 14	3.70 M	20.0	300	1-016	1-Ø12	Ø10դող 🤮 200mm
3.60 M	4.00 M		300	1-920	1-612	Ø10mm @ 200mm

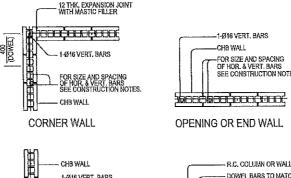

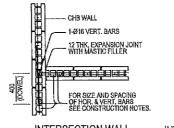


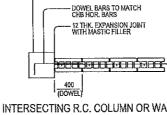


INTERSECTION WALL


INTERSECTING R.C. COLUMN OR WALL


### TYPICAL CONNECTION DETAIL OF MASONRY WALL

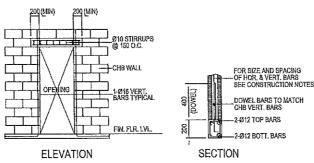


TYP, DET. OF LINTEL BEAM AT CHB WALL OPENING

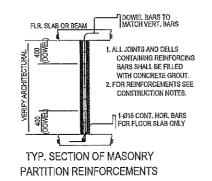


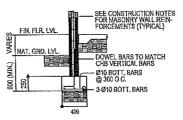


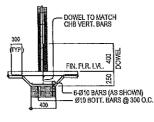

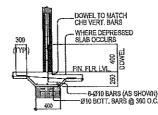

TYPICAL CHB FOOTING DETAILS (WHERE APPLICABLE)

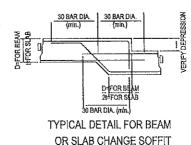

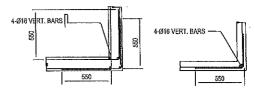

TYPICAL CONNECTION DETAIL OF R.C. WALL AT CORNERS

#### NOTES ON WELDS

- 1. USE E60xx ELECTRODES FOR ALL MEMBERS WELDED.
- 2. WELDS SHALL DEVELOP THE FULL STRENGTH OF MEMBERS JOINED UNLESS OTHERWISE SHOWN OR DETAILED IN THE DRAWINGS.

#### NOTES ON STRUCTURAL STEEL


- 1. STRUCTURAL STEEL TO BE USED FOR FABRICATION AND ERECTION OF THIS STRUCTURE SHALL COMPLY WITH ALL THE PERTINENT PROVISION OF AISC SPECIFICATION FOR THE DESIGN, FABRICATION AND ERECTION OF STRUCTURAL STEEL FOR BUILDING LATEST EDITION.
- 2. ALL STRUCTURAL STEEL SHAPES SHALL CONFORM TO ASTM A36 STRUCTURAL STEEL UNLESS OTHERWISE INDICATED.
- 3, ALL WELDED CONNECTIONS SHALL DEVELOP THE FULL STRENGTH OF THE MEMBERS CONNECTED.
- 4. UNLESS OTHERWISE SPECIFIED ALL WELDING RODS SHALL CONFORM WITH
- 5, ALL BOLTS USED UNLESS OTHERWISE SPECIFIED SHALL BE ASTM A 307 BOLTS,

#### NOTES ON EMBBED PIPES

- 1 ALL EMBEDED PIPES FOR UTILITIES FTC. THAT PASS THRU BEAMS SHALL NOT EXCEED 100mm IN DIAMETER OR 1/3 BEAM DEPTH WHICHEVER IS LESS, UNLESS OTHERWISE APPROVED IN WRITING BY THE STRUCTURAL ENGINEER.
- 2. NO PIPES SHALL BE ALLOWED TO PASS THRU BEAMS VERTICALLY.
- 3. NO PIPES SHALL BE EMBEDDED IN COLUMNS.

#### NOTES ON CONSTRUCTION JOINTS IN CONCRETE

1, WHERE A CONSTRUCTION JOINT IS TO BE MADE, THE SURFACE OF CONCRETE SHALL BE CLEANED AND ALL LAITANCE AND STANDING WATER REMOVED SHEAR KEY SHALL BE PROVIDE AT THE JOINT.

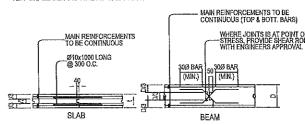


TYPICAL SLAB & BEAM CONSTRUCTION JOINT DET.

1. ALL WALLS SHALL BE REINFORCED ACCORDING TO THE FOLLOWING SCHEDULE OF WALL REINFORCEMENT LINLESS OTHERWISE INDICATED IN THE PLANS


WALL		REINFORCEMENT		VERTICAL
THICKNESS	HORIZONTAL	VERTICAL	REMARKS	SECTION
100mm	Ø10mm @ 250mm O.C.	Ø10mm @ 300mm O.C.		THE VER BARS
125mm	Ø10mm @ 200mm O.C.	Ø10mm @ 250mm O.C.	AT CENTERS VERTICAL	
150mm	Ø12mm @ 250mm O.C.	Ø12mm @ 300mm O.C.	BARS STAGGED OUT	HOR BARS


- 2. CARRY VERTICAL BARS AT LEAST 60mm ABOVE FLOOR LEVEL TO PROVIDE FOR SPLICES WHEN NECESSARY STOP AT 50mm BELOW TOP SLAB OR SOLID BAND WHERE THE WALL ENDS VERTICAL AND HORIZONTAL BARS SHALL BE SPLICED BY LAPPING A DISTANCE EQUAL TO 30 DIAMETERS AND WIRED SECURELY WITH 16 G.I. WIRE
- AROUND WITH 2-20mm@ BARS, FOR 225mm, 200mm, 175mm, 150mm THICK WALLS, USE 2-16mm@. FOR 125mm AND 100mm THICK WALLS, USE 2-12mmØ BARS. ALL WALLS SPANNING SHALL HAVE VERTICAL REINFORCEMENT BENT A U-FORM LIKE STIRRUPS AND SPACED ACCORDING TO THE SCHEDULE UNLESS OTHERWISE NOTED.

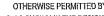


NOTES ON STIRUPS

- 1. ALL REINFORCEMENT SHALL BE BENT COLD UNLESS OTHERWISE PERMITTED BY THE STRUCTURAL ENGINEER.
- AS SHOWN IN THE DESIGN DRAWINGS OR PERMITTED BY THE STRUCTURAL ENGINEER.
- 3, TIES & CLOSE STIRRUPS MUST BE AT 135,

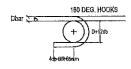

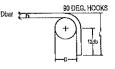

		END HOOK GRADES)	S	
BAR SIZE	DIAMETER	1°031	100K	80, HOOK
(DEFORMED)	(mm)	D+2db	1	L
10 mm Ø	£0	75	125	150
12 mm Ø	75	100	150	200
15 mm, Ø	95	125	175	250
20 mm Ø	115	150	200	300
25 mm £0	150	200	230	450
28 mm Ø	240	300	350	550
32 mm Ø	300	335	450	600

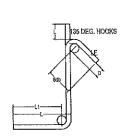

	STIRRUP ANI (ALL:	) THE TIE H GRADES)	DOKS	
BAR SIZE	DIAMETER	180° H	COK	60. HOOK
(DEFORMED)	(rnm)	D+2db	L	L
10 mm 85	40	125	85	100
12 mm 95	50	165	115	115
16 mm Ø	65	200	140	150
20 mm Ø	115	\$00	185	300
32 mm Ø	150	335	230	405


#### NOTES ON CONCRETE WALLS

REVIEWED 8


WALL	WALL REINFORCEMENT					
THICKNESS	HORIZONTAL	VERTICAL	REMARKS	VERTICAL SECTION		
100mm	Ø10mm @ 250mm O,C,	Ø10mm @ 300mm O.C.		THE VER. BARS		
125mm	Ø10mm @ 200mm O.C.	Ø10mm @ 250mm O.C.	AT CENTERS VERTICAL			
150mm	Ø12mm @ 250mm O.C.	Ø12mm @ 300mm O.C.	BARS STAGGED OUT	HOR BARS		

REINFORCING BARS SHALL HAVE 25mm CLEAR CONCRETE COVER FROM FACE OF WALL EXCEPT FOR WALLS IN CONTACT WITH THE GROLIND WHERE A MINIMUM OF 60mm SHALL BE PROVIDED AND FOR EXPOSED FACES OF FORMED WALLS WHERE THE MINIMUM SHALL BE 50mm CLEAR.

- PROVIDED THAT SPLICES IN ADJACENT BARS ARE STAGGERED AT LEAST 1.50M O.C.
- 3. UNLESS OTHERWISE NOTED IN THE PLANS, ALL OPENINGS IN WALLS 250mm OR THICKER SHALL BE REINFORCED

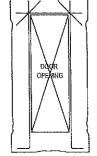

APPROVED BY

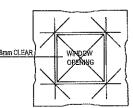

TYP, EXTERIOR WDW. & DOOR OPENING



REPUBLIC OF THE PHILIPPINES PROVINCIAL ENGINEER'S OFFICE SAN AGUSTIN, DIGOS CITY, DAVAO DEL SUR

CONSTRUCTION AND IMPROVEMENT OF

GREGORIO MATAS DISTRICT HOSPITAL (GMDH)

FRANKLIN N. ISLA III ENGINEERING ASSISTANT

REPARED BY


R. GONZALES PROGRAMMING DIV HEAD RECOMMENDING PPROVAL: LEONERL MARCH P. SUARIO PROVINCIAL ENGINEER


S-2


SHEET NO.

5

POBLACION, KIBLAWAN, DAVAO DEL SUR

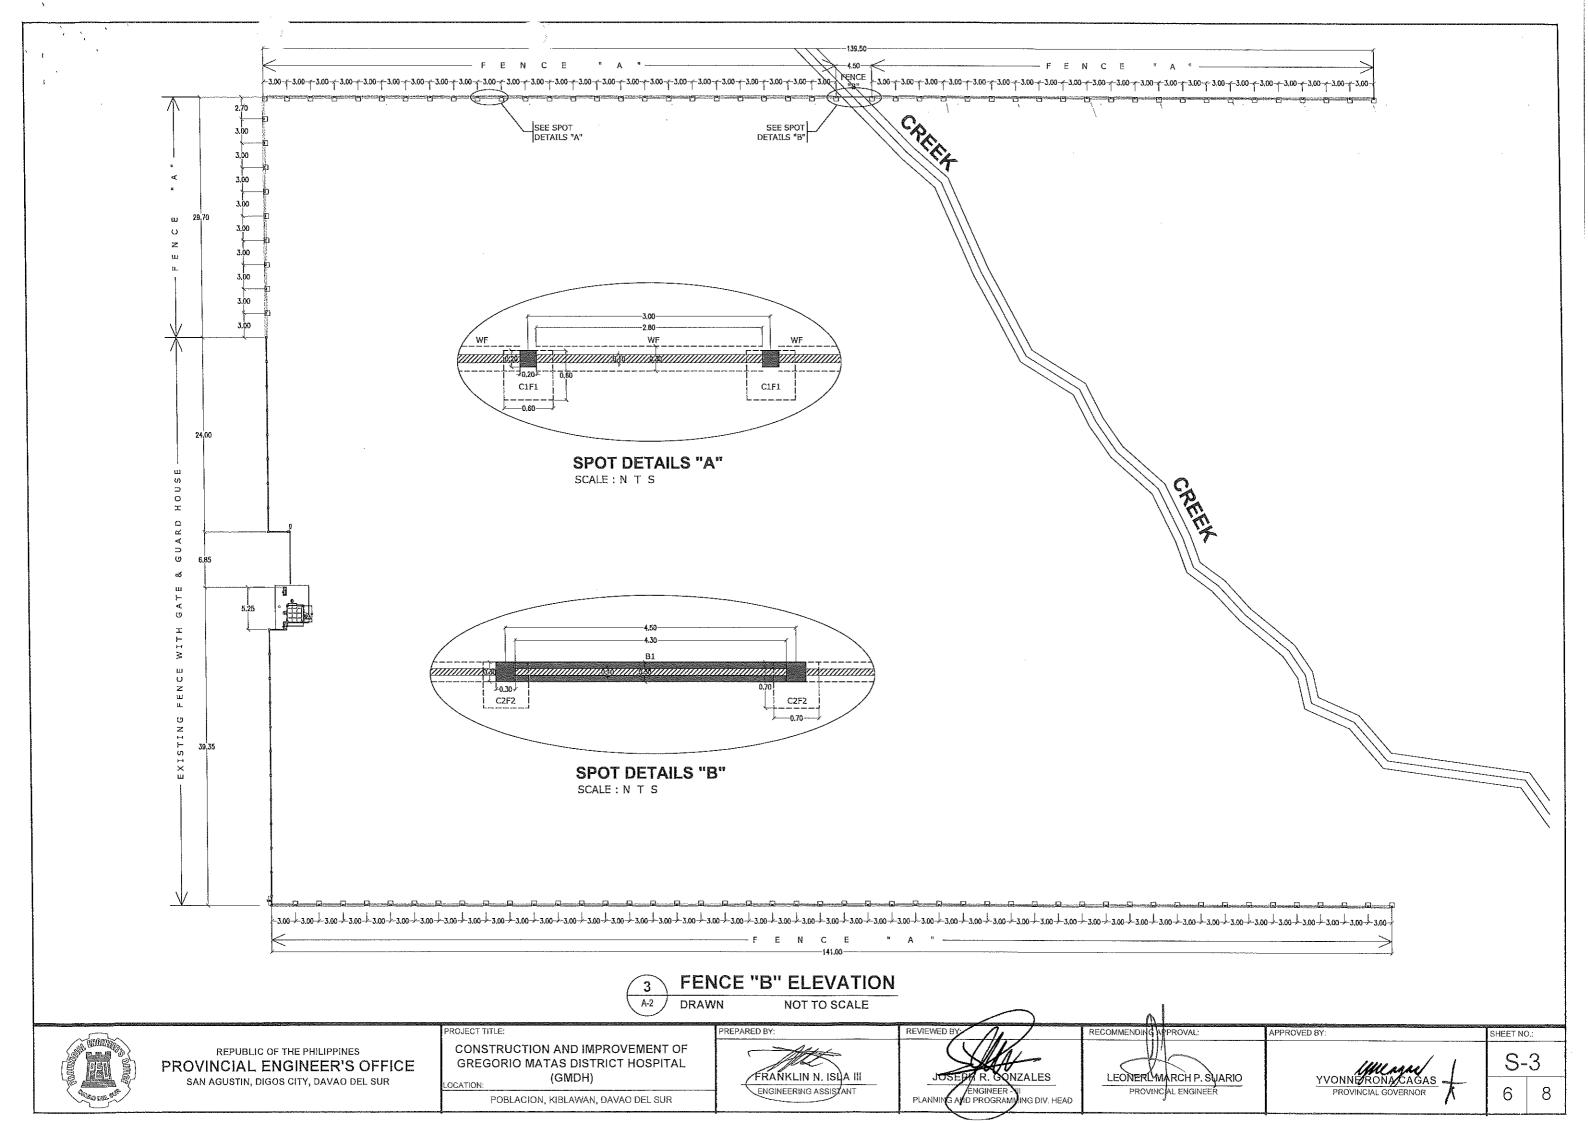

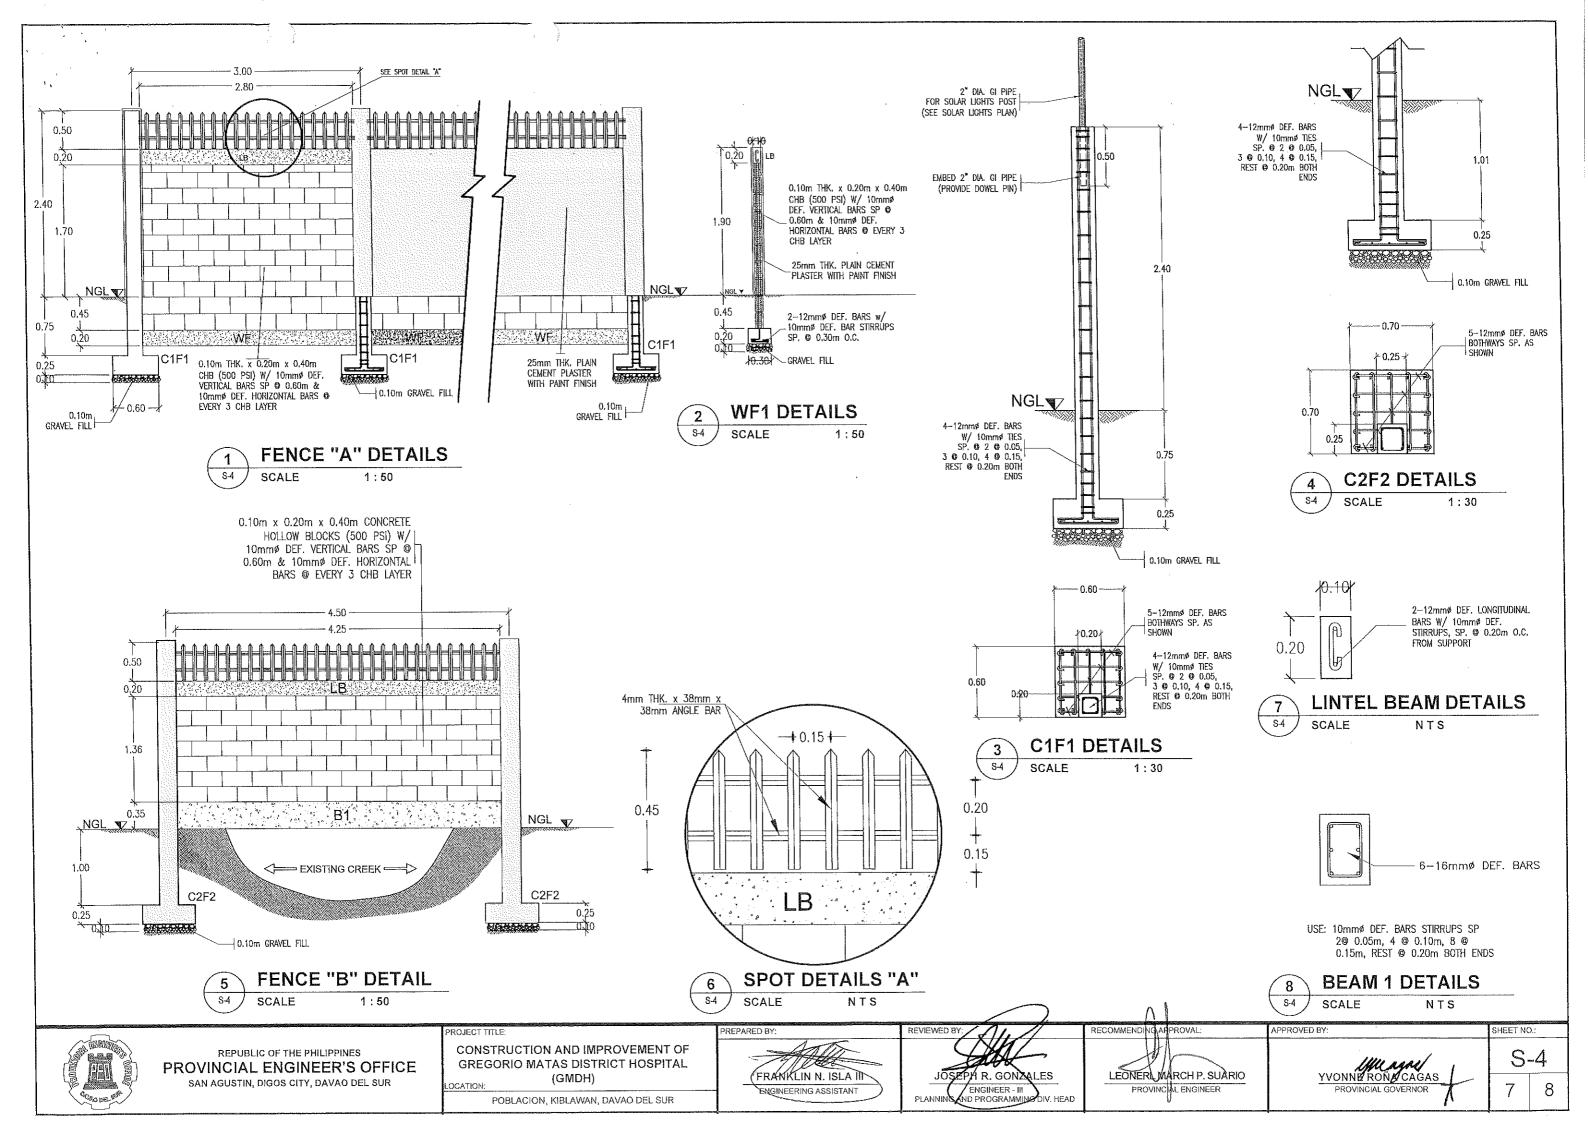


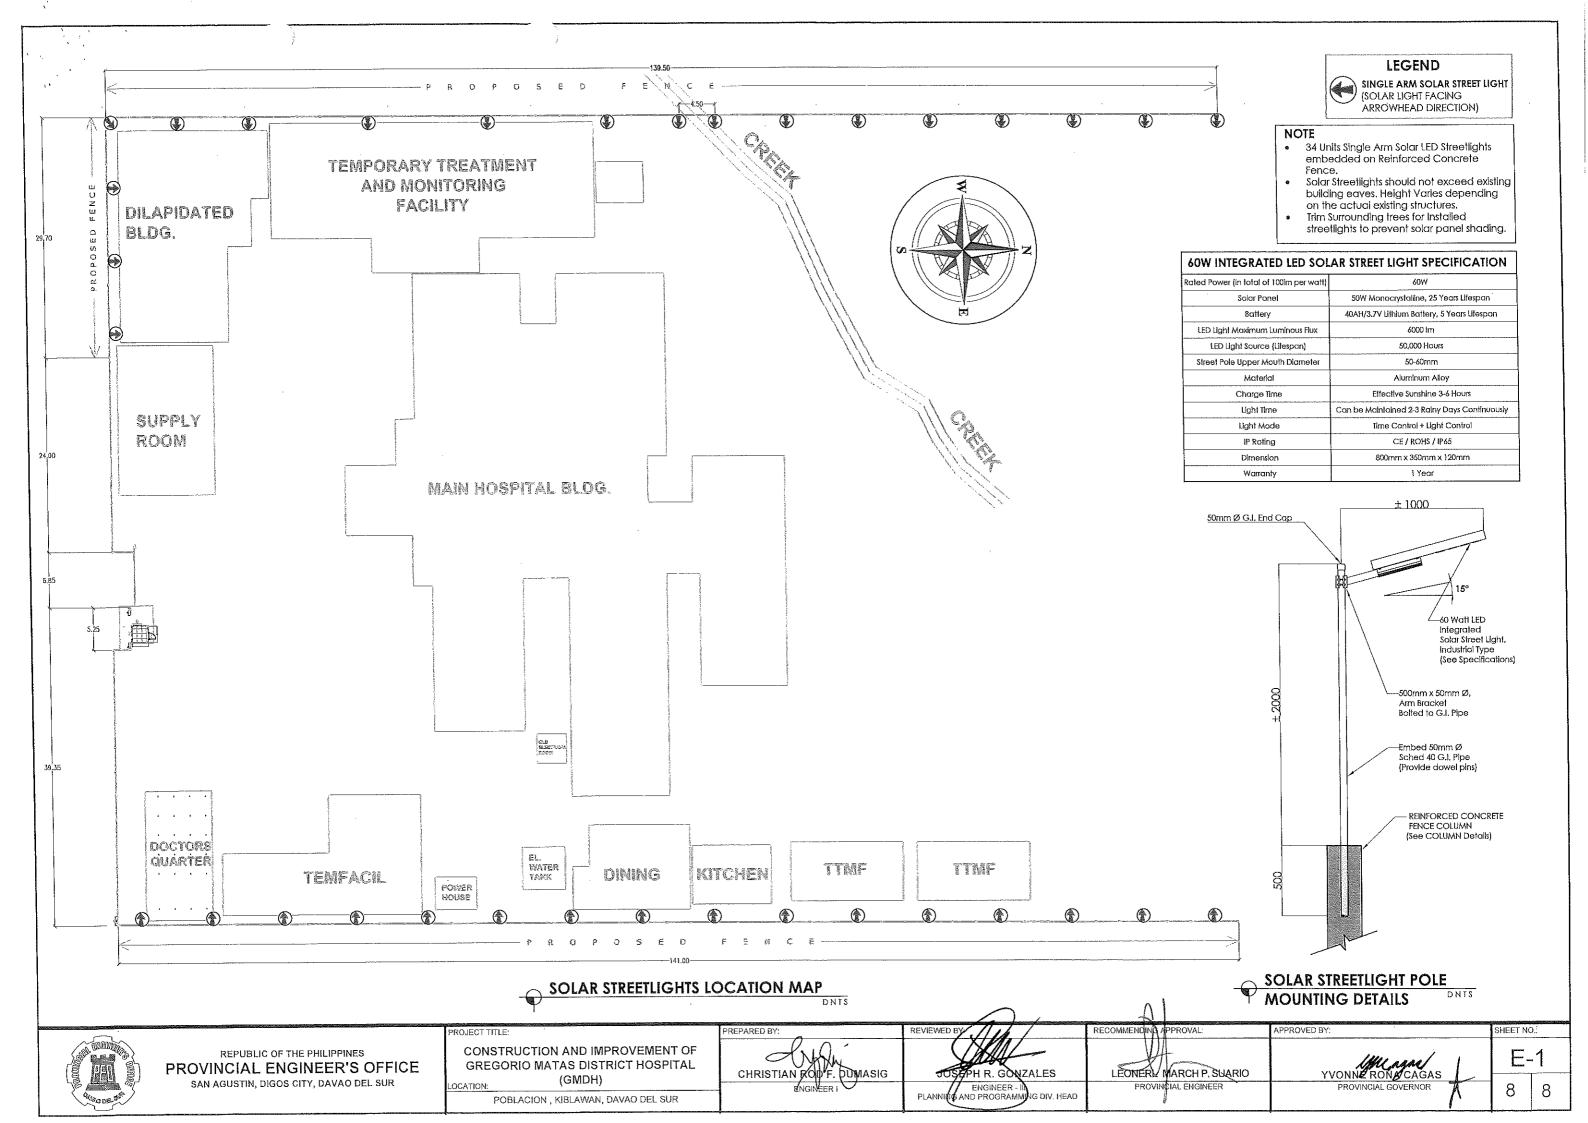

4. CADAVER HOLDING AREA





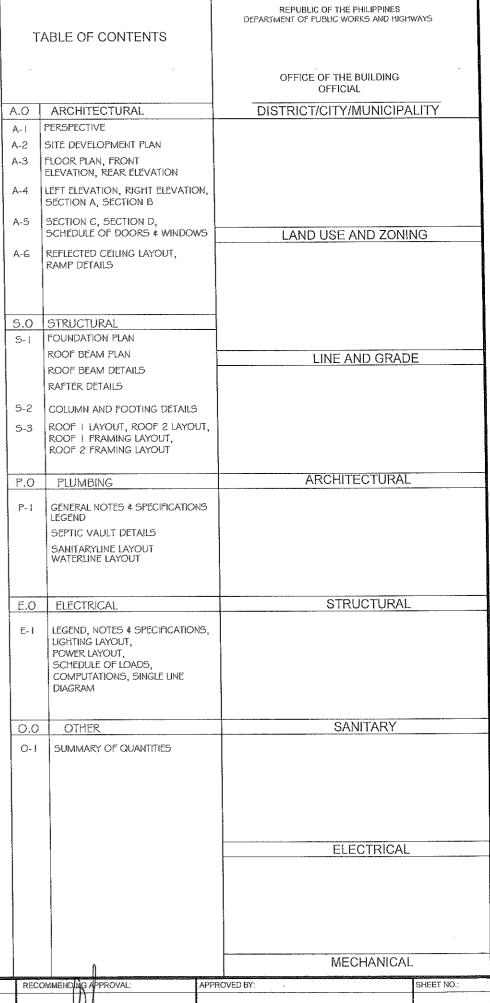



REPUBLIC OF THE PHILIPPINES PROVINCIAL ENGINEER'S OFFICE SAN AGUSTIN, DIGOS CITY, DAVAO DEL SUR

CONSTRUCTION AND IMPROVEMENT OF GREGORIO MATAS DISTRICT HOSPITAL (GMDH)

POBLACION, KIBLAWAN , DAVAO DEL SUR

ADNAN SHAMIR L. PIÑOL ARCHITECT ||

REPARED BY:


FNGINEER - II


LEONERL MARCH P. SUARIO

PROVINCIAL ENGINEER

A-1

YVONNE ROMA CAGAS PROVINCIAL GOVERNOR

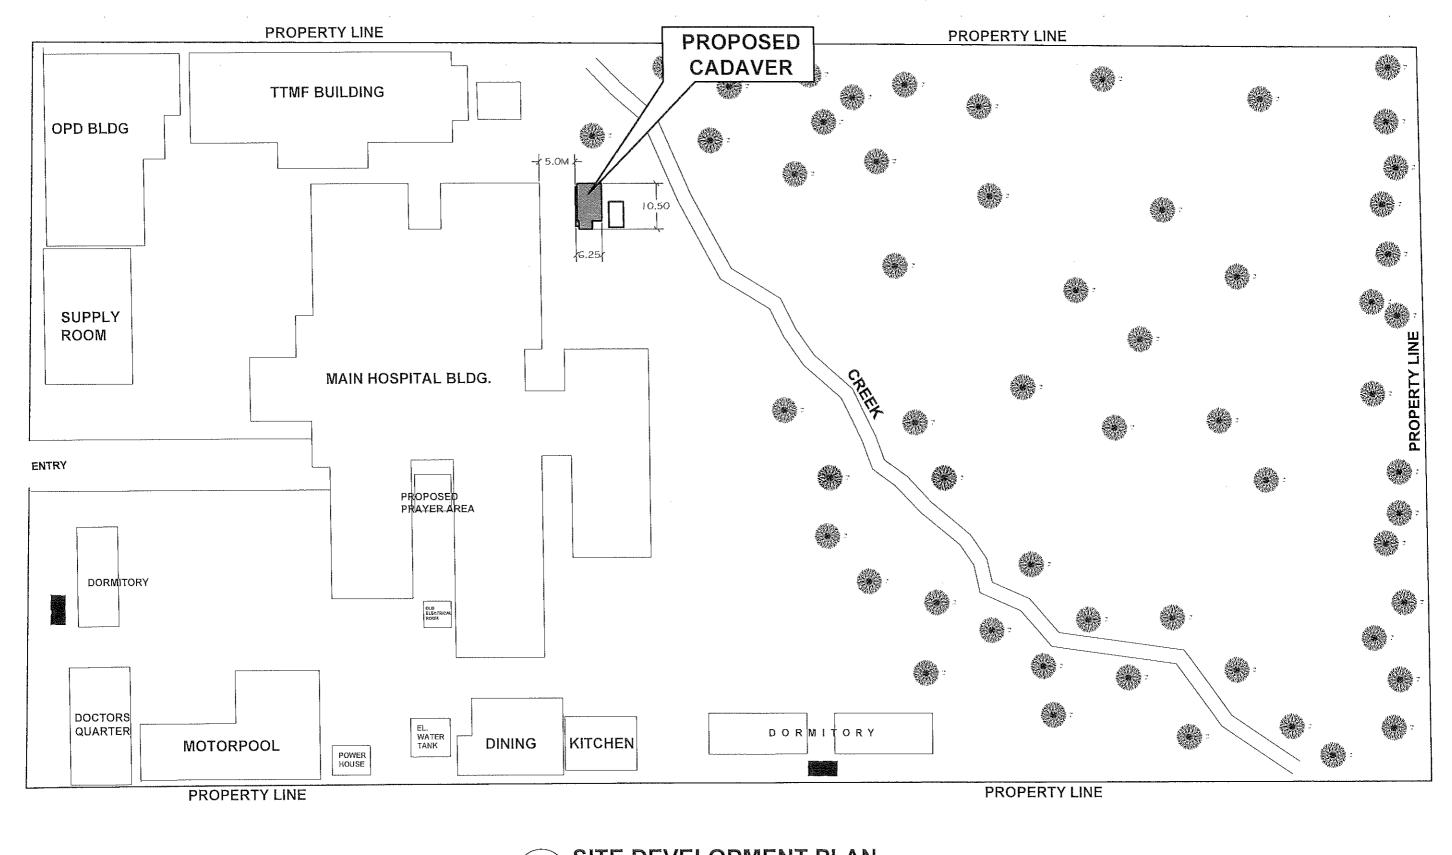

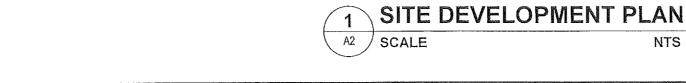



REPUBLIC OF THE PHILIPPINES PROVINCIAL ENGINEER'S OFFICE SAN AGUSTIN, DIGOS CITY, DAVAO DEL SUR

CONSTRUCTION AND IMPROVEMENT OF GREGORIO MATAS DISTRICT HOSPITAL (GMDH) POBLACION, KIBLAWAN , DAVAO DEL SUR


PREPARED BY: ADNAN SHAMIR L. PIÑOL REVIEWED BY


RECOMMENDIN LEONERL WARCH P. SUARIO PROVINCIAL ENGINEER


APPROVED BY: IfMagae/ YVONNE ROM CAGAS


A-2

SHEET NO,:

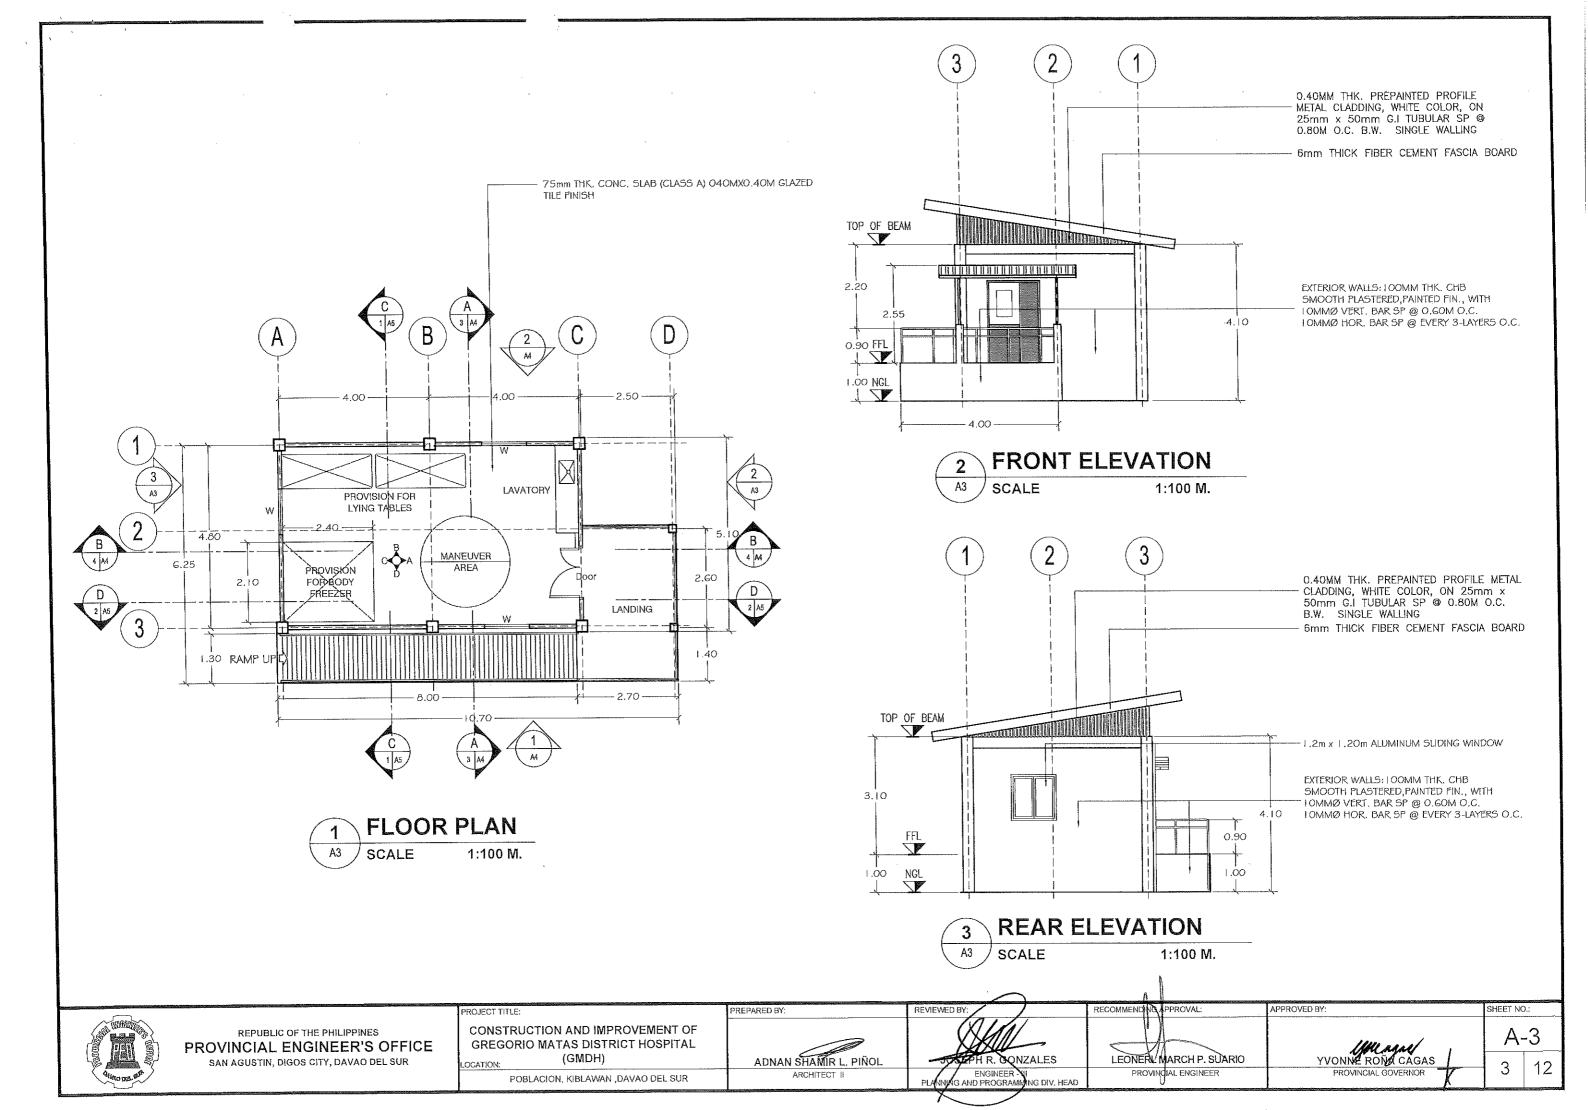


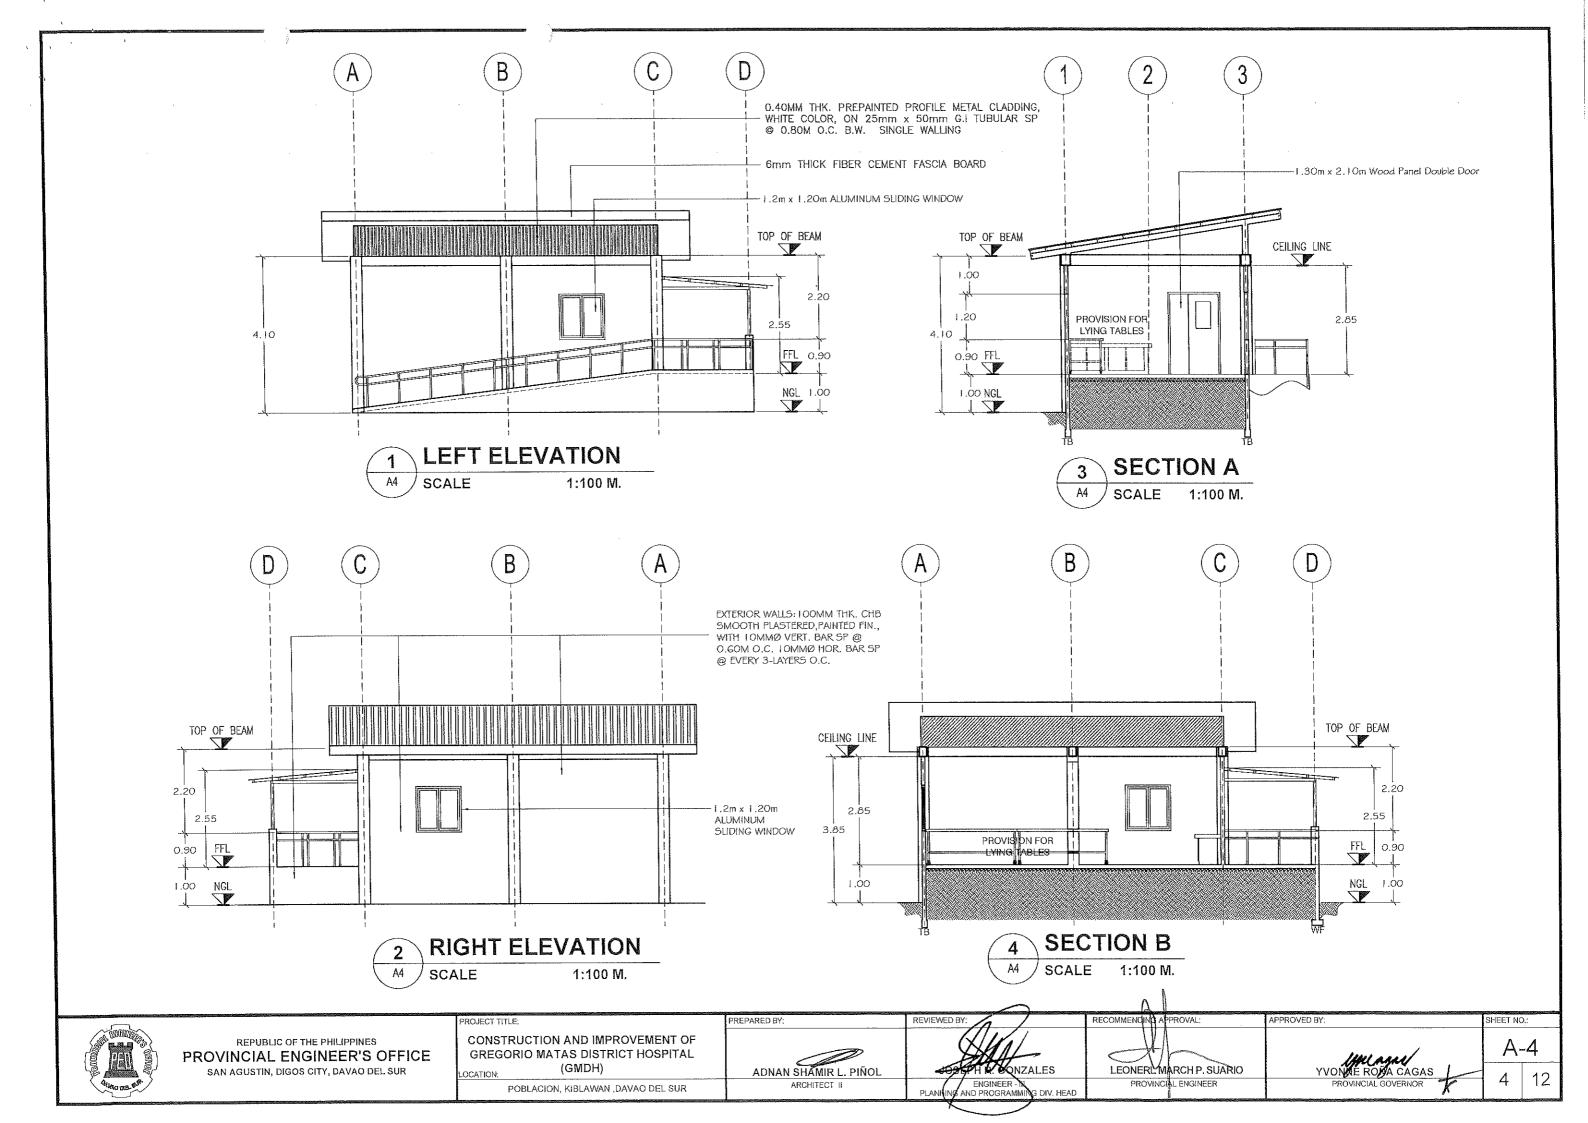

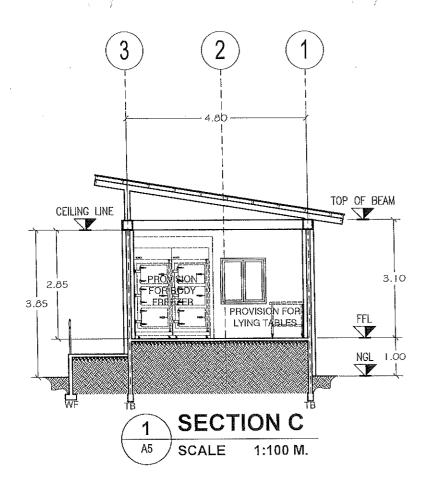

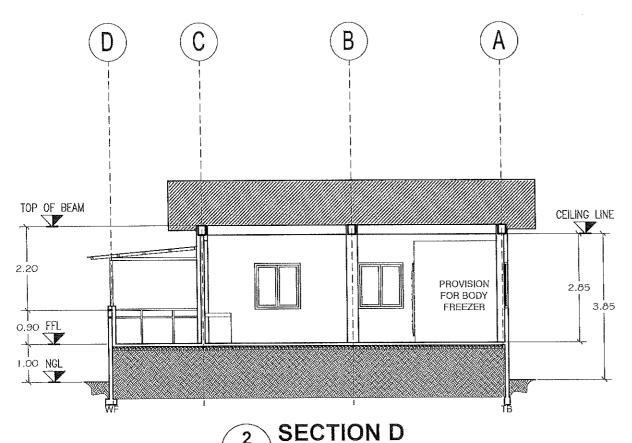

SCALE

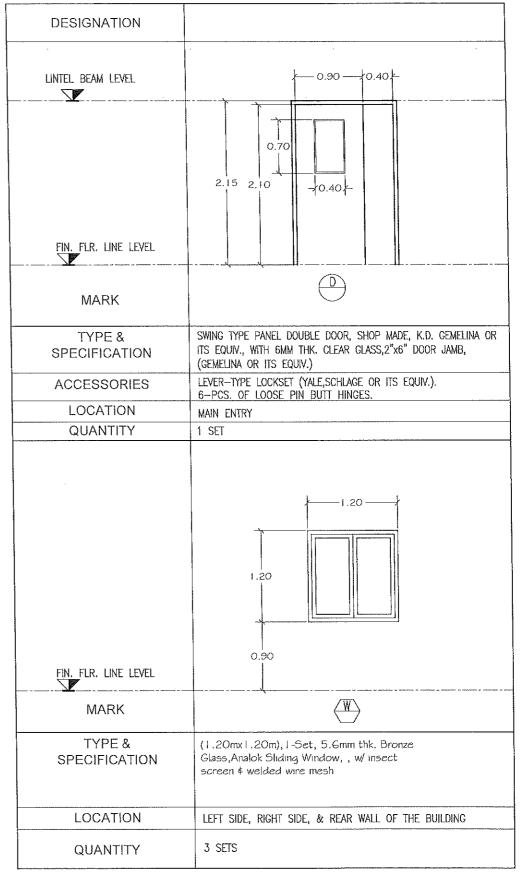

#### **SCHEDULE OF DOORS & WINDOWS** 3 A5

SCALE

1:50 M.

APPROVED BY:



REPUBLIC OF THE PHILIPPINES PROVINCIAL ENGINEER'S OFFICE SAN AGUSTIN, DIGOS CITY, DAVAO DEL SUR

PROJECT TITLE:

1:100 M.

CONSTRUCTION AND IMPROVEMENT OF GREGORIO MATAS DISTRICT HOSPITAL (GMDH)

POBLACION, KIBLAWAN , DAVAO DEL SUR

ADNAN SHAMIR L. PIÑOL ARCHITECT II

REPARED BY:

HR. SONZALES ENGINEER -

REVIEWED BY


LEONER MARCH P. SUARIO PROVINCIAL ENGINEER


RECOMMENDING APPROVAL:


YVONNE RONG CAGAS
PROVINCIAL GOVERNOR


A-5


SHEET NO.:

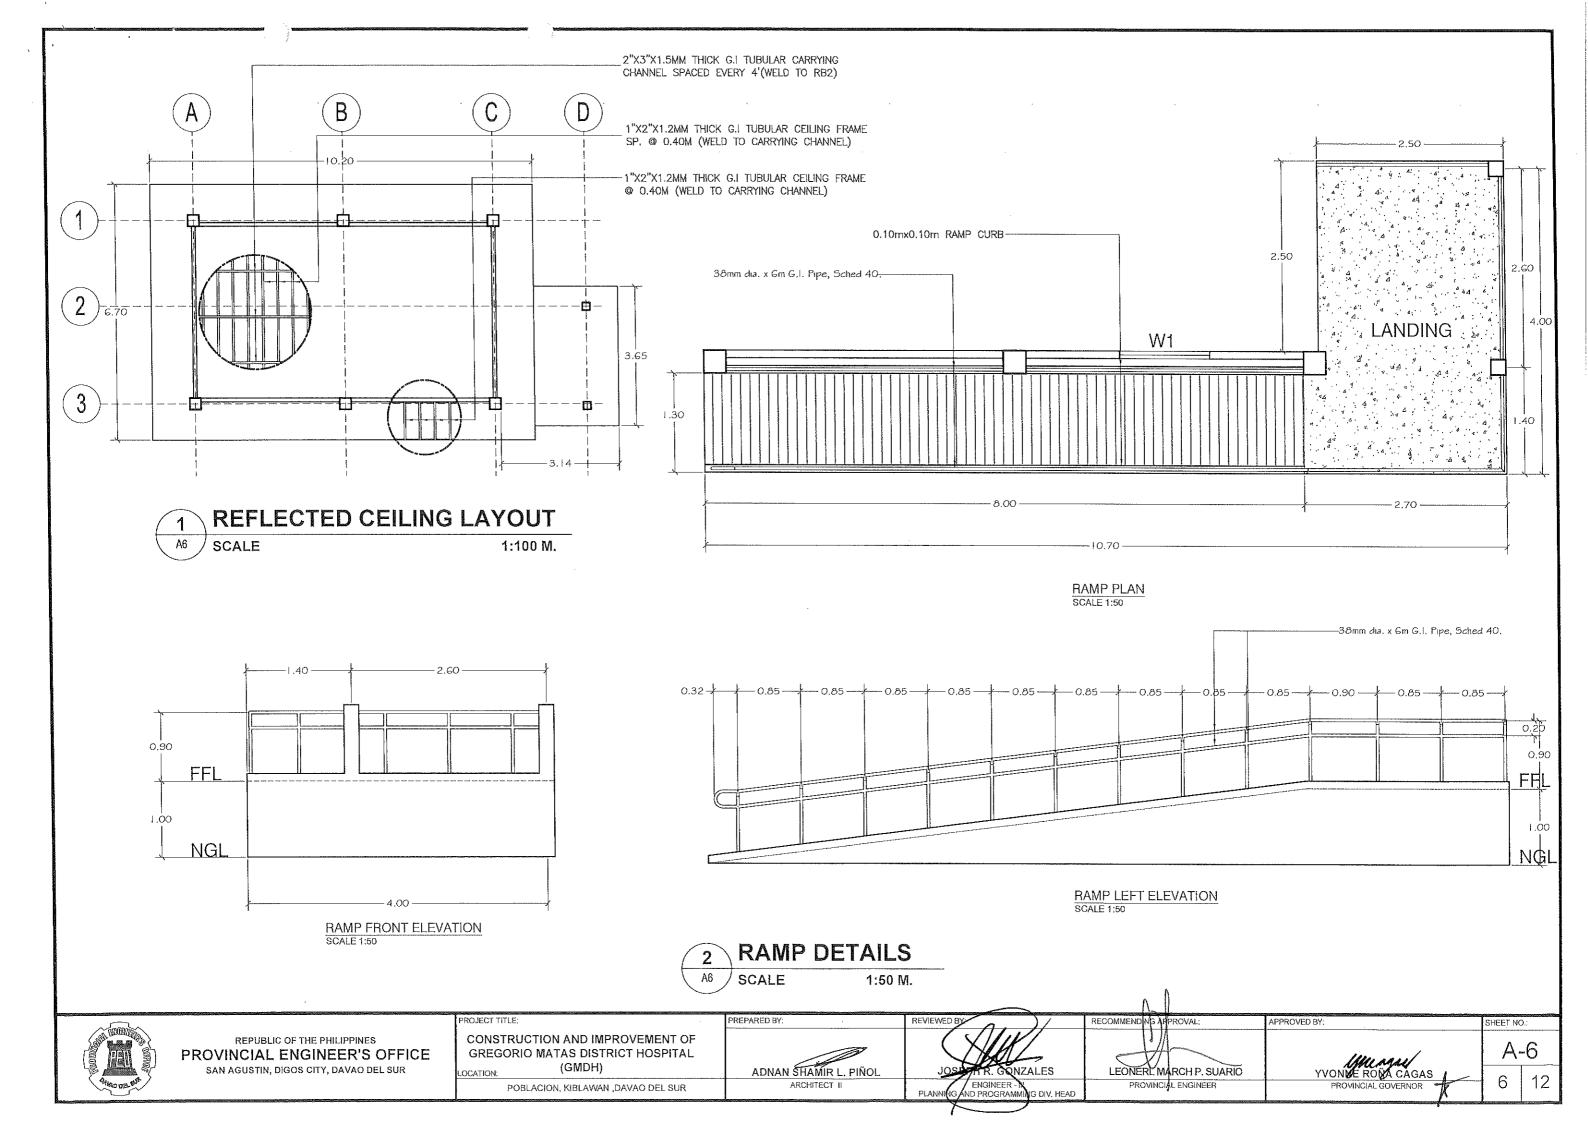


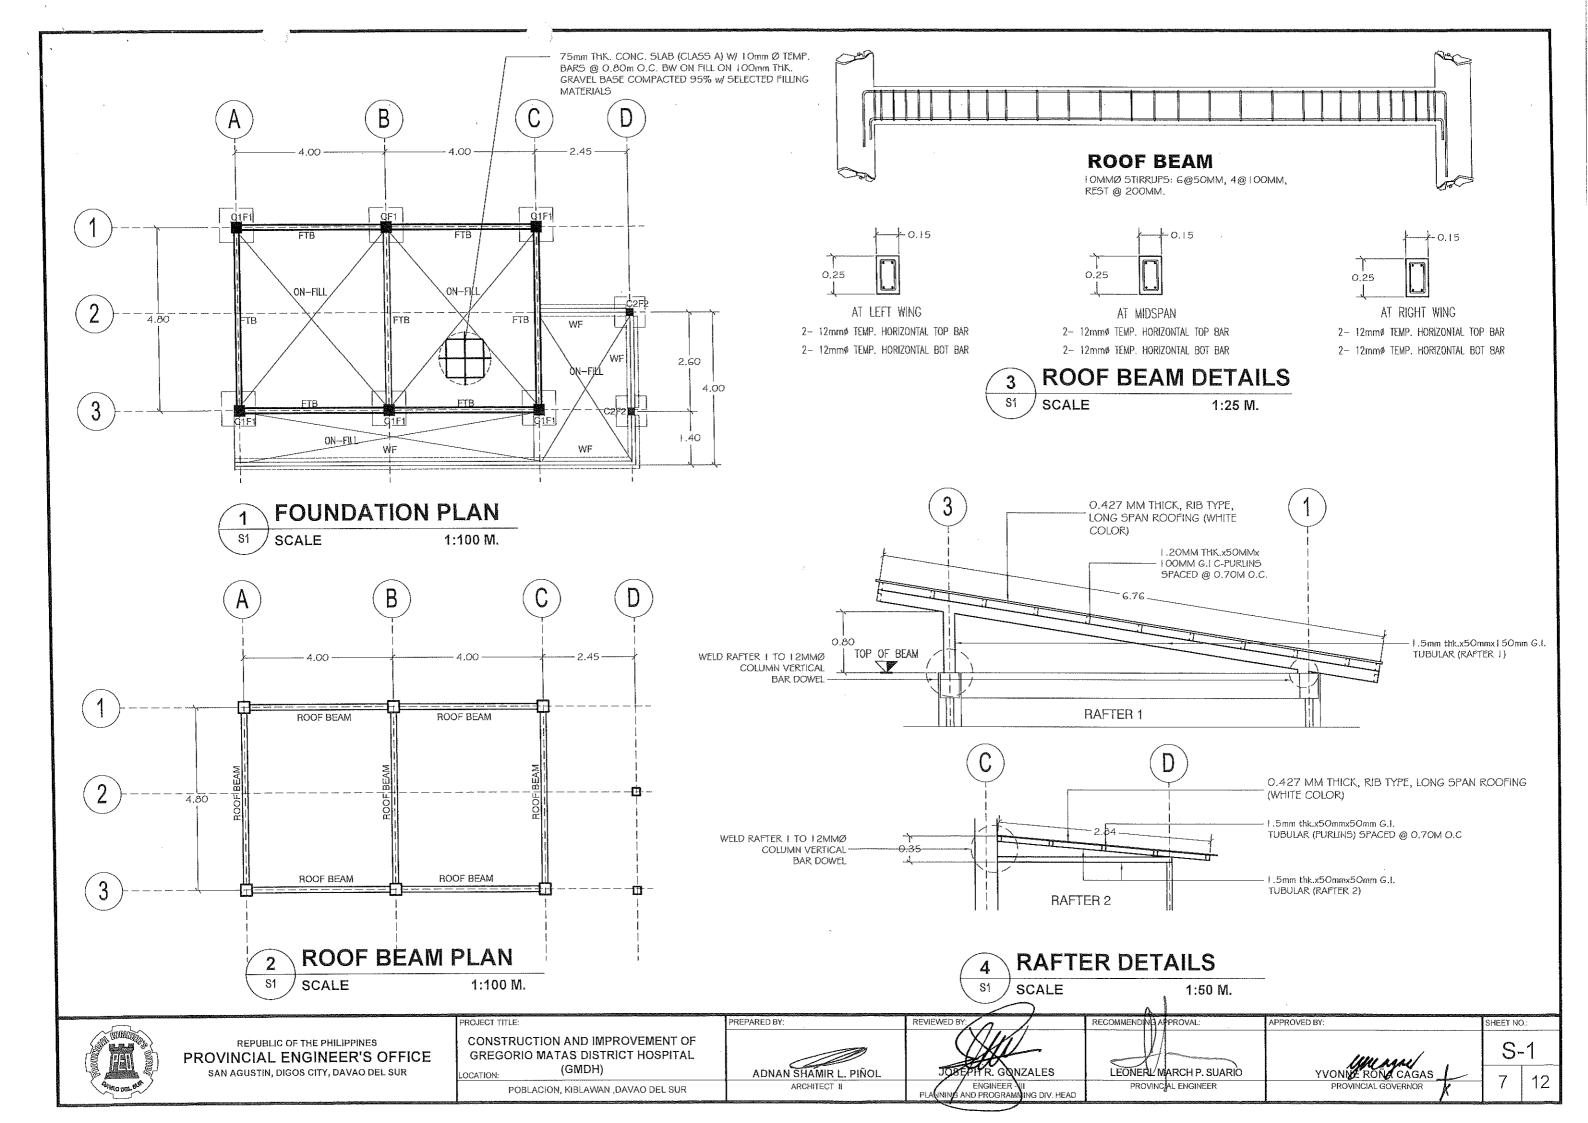

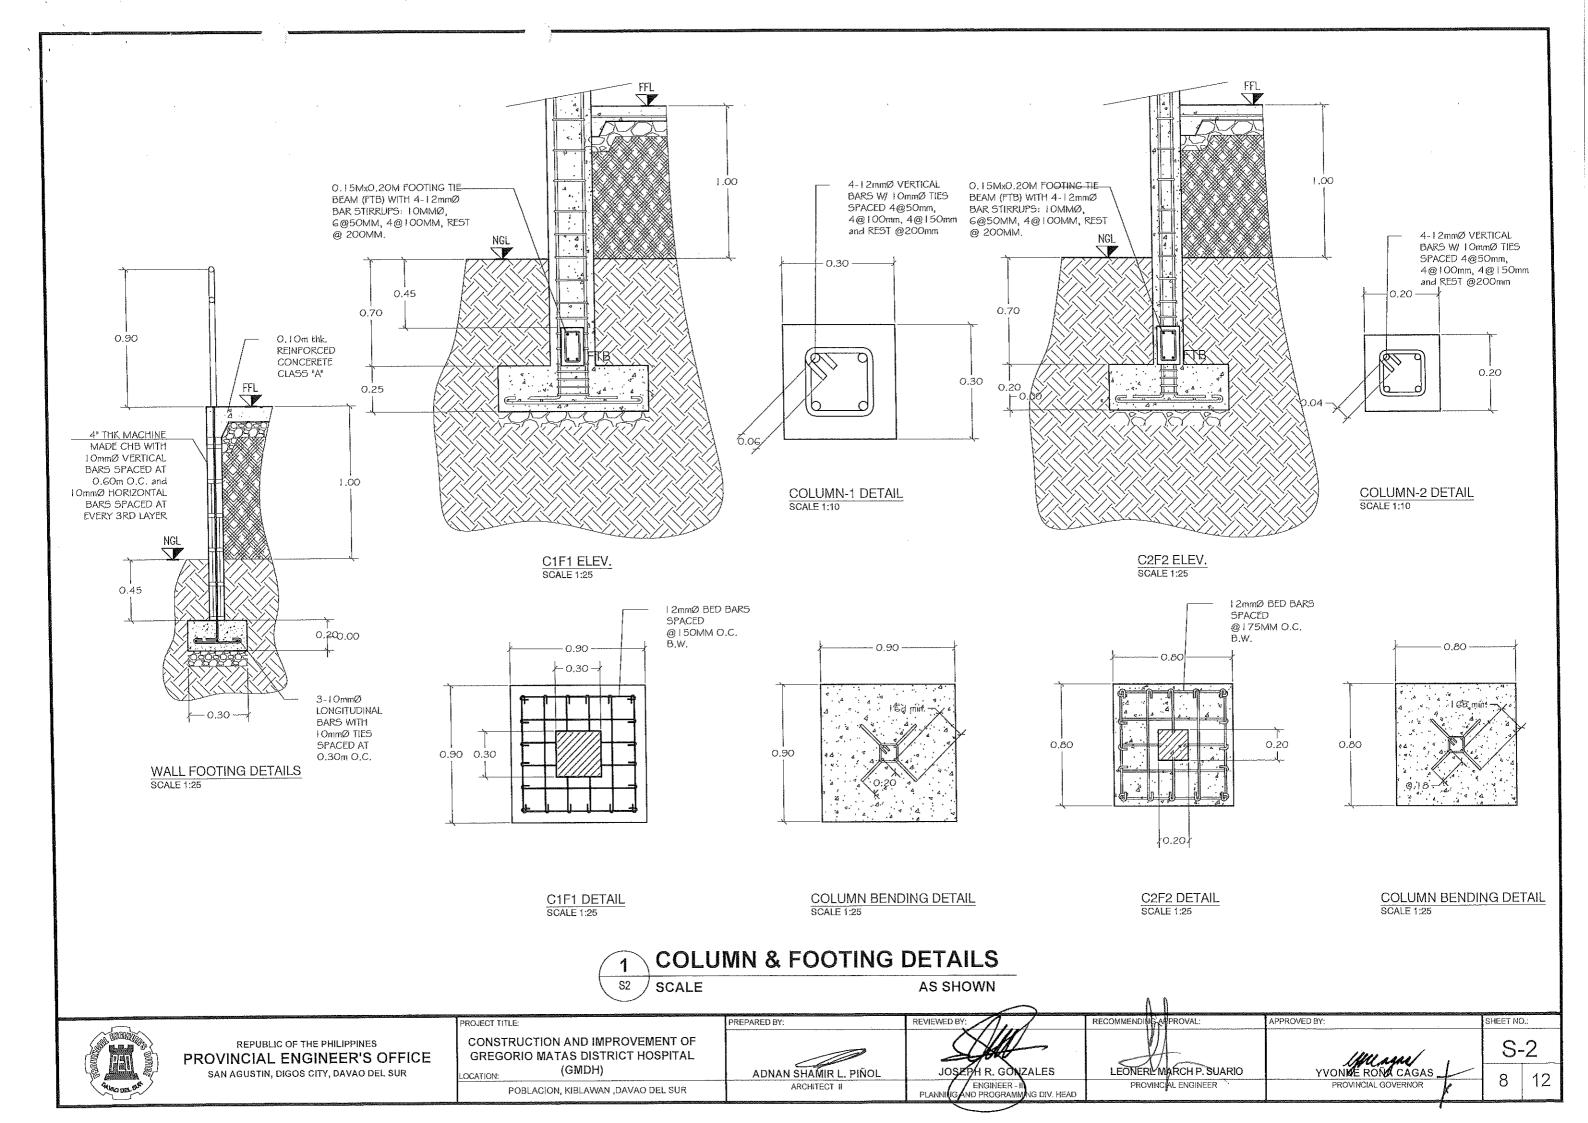

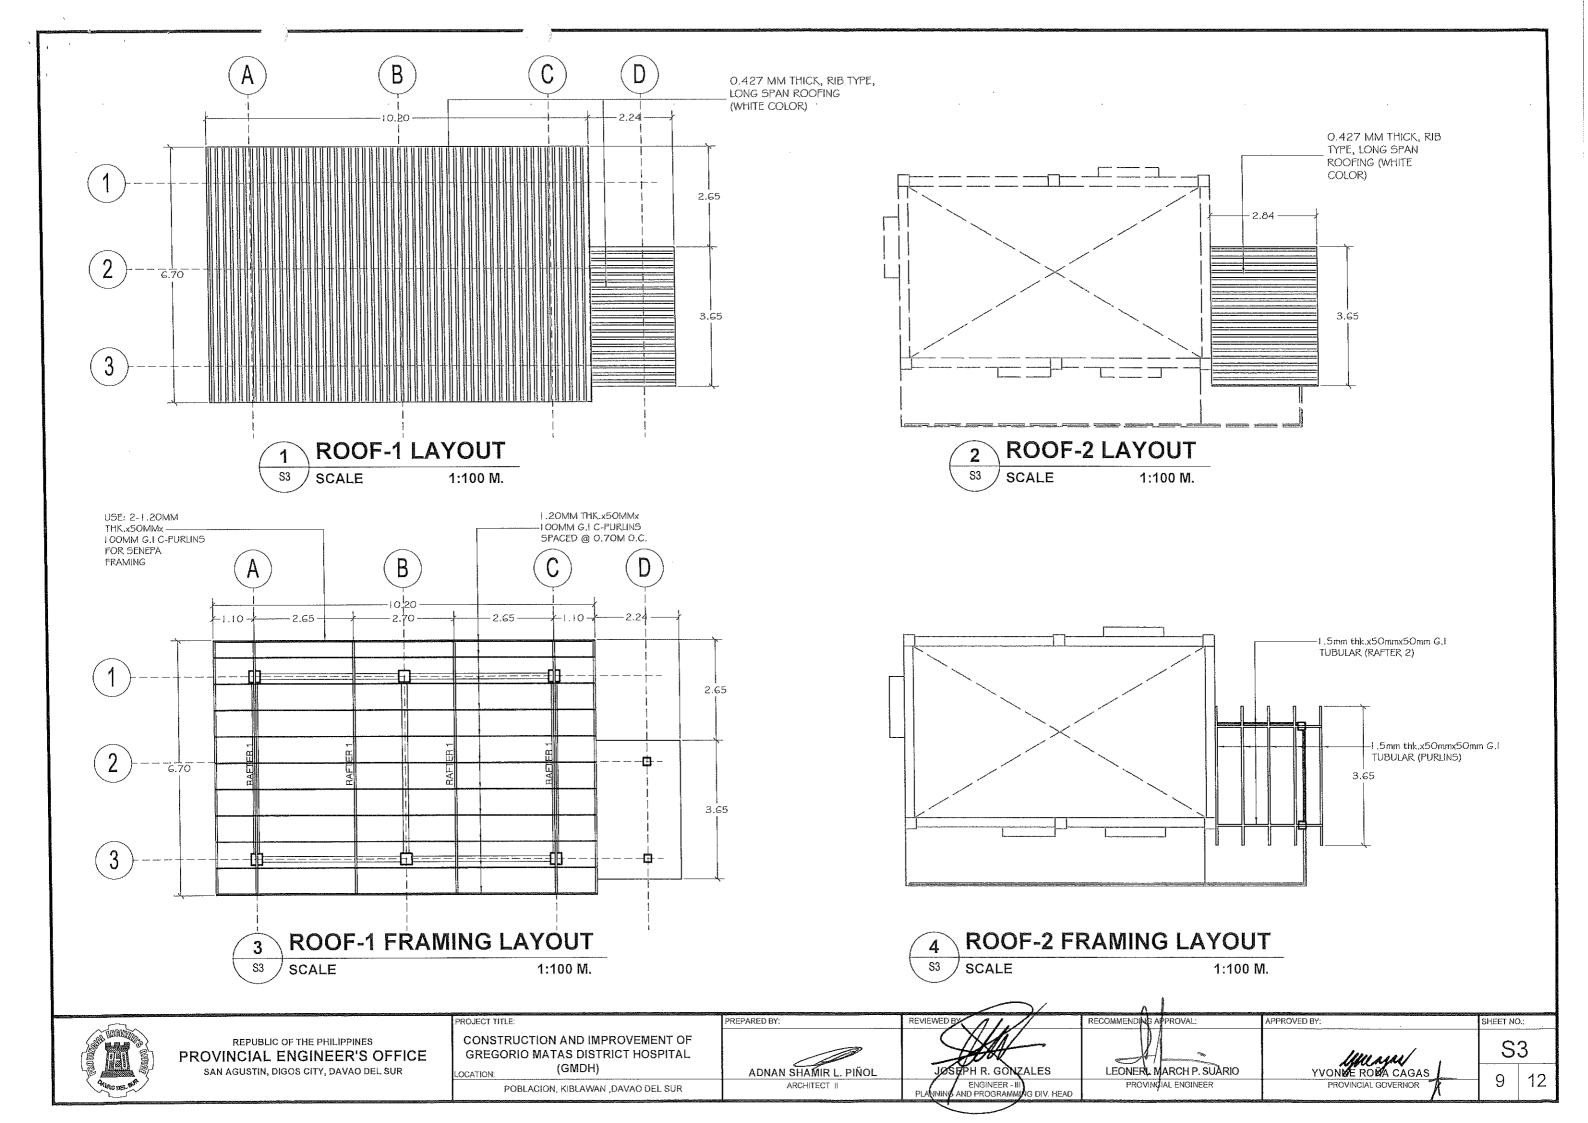

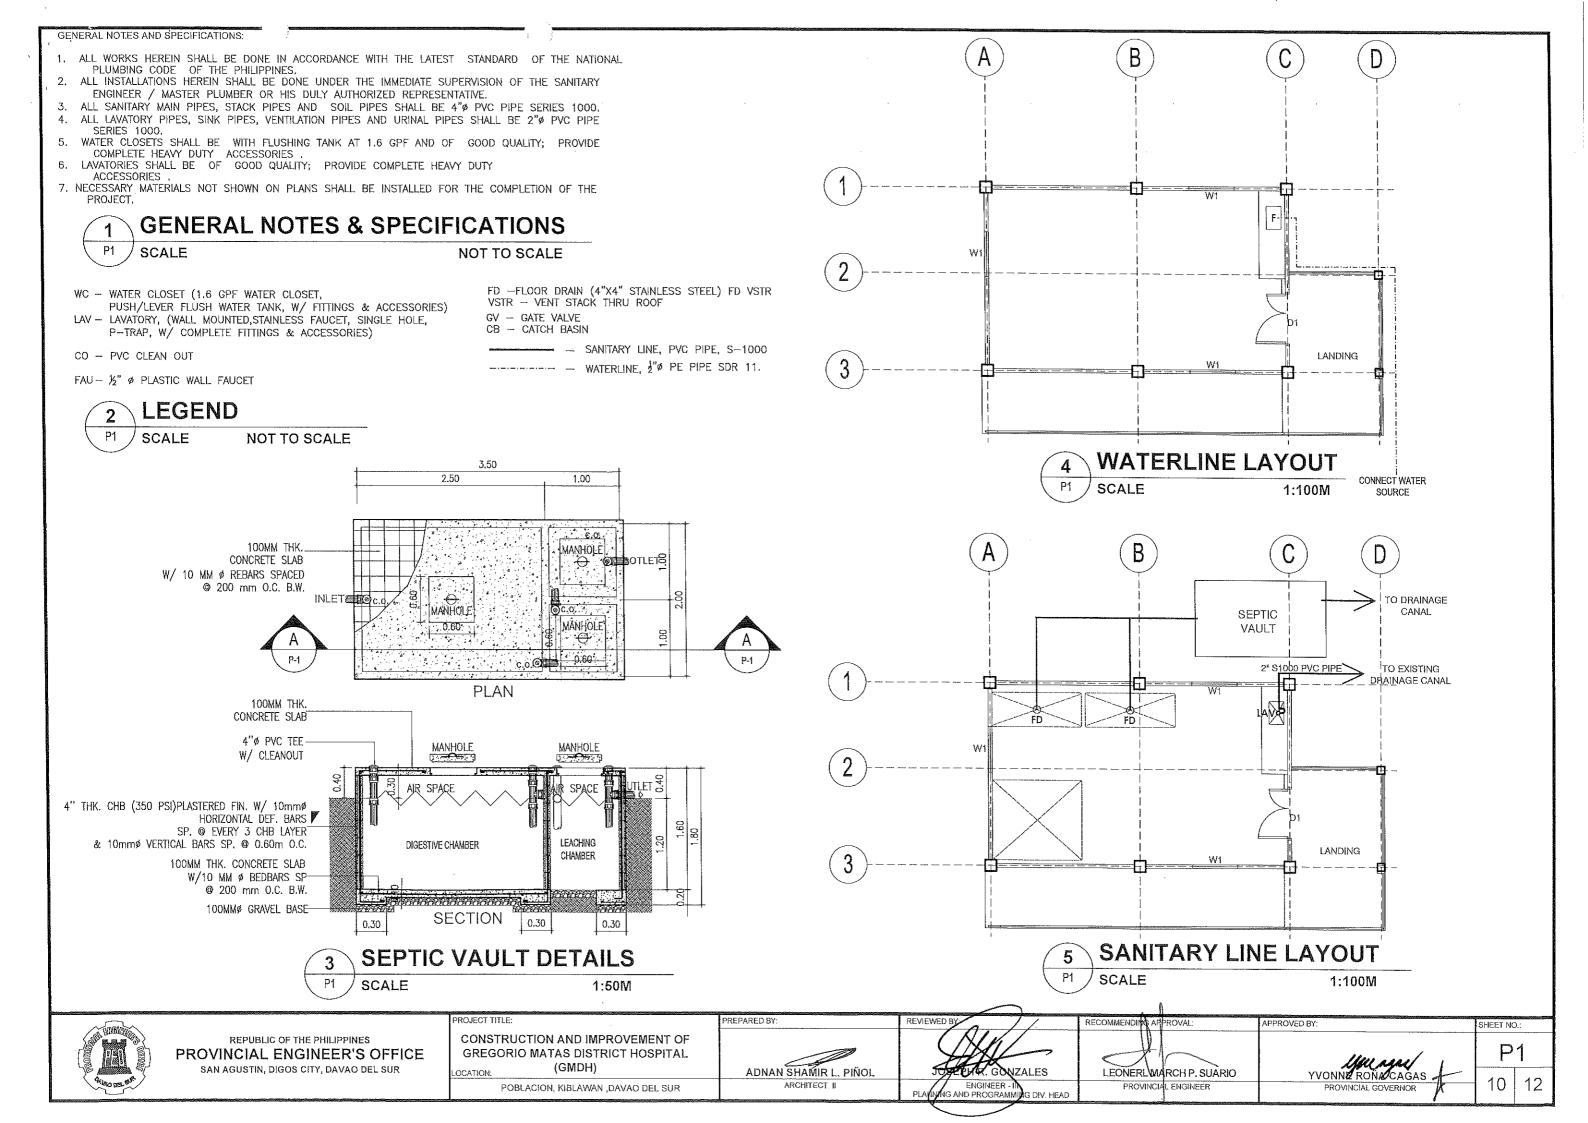

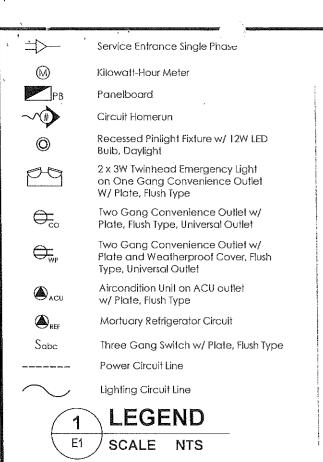

All Electrical Installations herein shall be in accordance with the Latest Rules & Regulations of the Philippine Electrical Code and the Local Power Company.

Wirings passing through concrete masonry, ceilings, columns, beams, slabs must be concealed type using

Whenever Necessary, Pull Box of Proper Sizes and Dimensions shall be provided. Although not indicated in

Provide Circuit Directory to be located inside the

All Electrical works herein must be done only under the

direct supervision of a duly registered Electrical Engineer

1,37m

1,83m

1.83m

All Electrical materials to be installed herein must be


brand new and of approved type & quality.


PVC Pipe or Flexible Pipe.

Panelboard for Circuit Identification.

Mounting Heights above Finish Floor Line

Convenience Outlet 0,30m

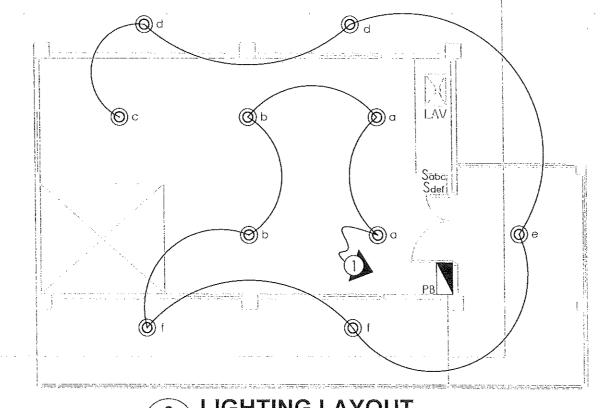


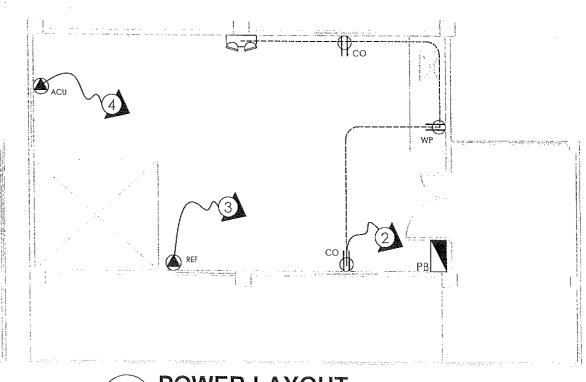

## LIGHTING LAYOUT E1 **SCALE**

**POWER LAYOUT** E1 **SCALE** NTS

CIRCUIT NO.	DESCRIPTION	QUANTITY	VOLTAGE	VOLT-AMP	CURRENT (AMPERE)	CIRCUIT BREAKER	CONDUCTOR SIZE	CONDUIT SIZE
C1	LIGHTING OUTLET (PINLIGHTS)	10	230	1,000	4.35	20 A	2 - 3,5mm² THHN Stranded Copper Wire	20mm Ø PVC
C2	CONVENIENCE OUTLET & EMERGENCY OUTLET	4	230	630	2.74	20 A	2 - 3.5mm² THHN Stranded Copper Wire	20mm Ø PVC
СЗ	REFRIGERATOR CIRCUIT	1	230	2,000	8.70	30 A	2 - 5.5mm² THHN Stranded Copper Wire	20mm Ø PVC
C4	AIRCONDITIONING UNIT, 2 HP SPLIT TYPE , INVERTER	1	230	2,760	12	30 A	2 - 5.5mm² THHN Stranded Copper Wire	20mm Ø PVC
C5	SPARE		230	500		20 A		
C6	MAIN			6,890		40 A	2 - 8.0mm² THW Stranded Copper Wire	25mm Ø RSC

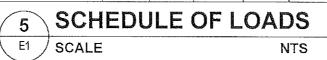

I<sub>L</sub> = (Total Load x 85% Demand Factor) + 25% Highest Motor Load

 $I_L = (29.96 \times 0.85) + (12 \times 0.25)$ 

= 28.47 A

 $I_{CB} = I_L \times 125\%$ 

 $I_{CB} = 28.47 \times 125\%$ 


 $I_{CB} = 35.59 A$ 

USE

2 - 8.0mm<sup>2</sup> THW Stranded Copper Wire inside 25mm Ø RSC

40 AT, 240V, 2P, 60 Hz As Main Circuit Breaker

REVIEWED B

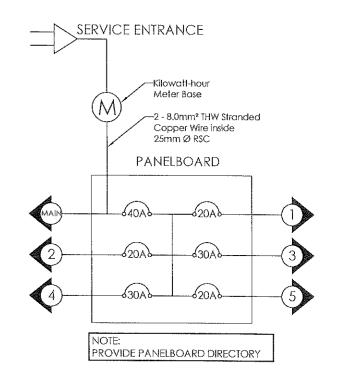

## NOTES AND SPECIFICATION

Center

Center

Center

Bottom

E1 **SCALE** 

or Master Electrician.

Switches

Panelboard

Kilowatt-Hour Meter

NTS

COMPUTATIONS

SCALE NTS

REPARED BY:



2

REPUBLIC OF THE PHILIPPINES PROVINCIAL ENGINEER'S OFFICE SAN AGUSTIN, DIGOS CITY, DAVAO DEL SUR

ROJECT TITLE:

CONSTRUCTION AND IMPROVEMENT OF GREGORIO MATAS DISTRICT HOSPITAL

(GMDH)

CHRISTIAN FOOD F. DUMASIG ENGINEER I ELECTRICAL ENGINEER)

AR. GONZALES ENGINEER

LEONERL MARCH P. SUARIO PROVINCIAL ENGINEER

RECOMMENDING APPROVAL:

E1

Murry. YVONNE ROMA CAGAS

SINGLE LINE DIAGRAM

NTS

PROVINCIAL GOVERNOR

APPROVED BY:

SCALE

POBLACION, KIBLAWAN, DAVAO DEL SUR

NG DIV. HEAD

11 | 12

SHEET NO.;

ITEM NO.	DESCRIPTION	%	QTY.	UNIT			
PART C	EA RTHWORK						
800(2)	Clearing and Grubbing	0.16	1.00	l.s.			
803(1)a	Structure Excavation, (Common Soil)	0.36	7.95	cu.m.			
804(7)	Gravel Fill	1.68	8.02	cu.m.			
***************************************	TOTAL OF PART C	2.20					
	REINFORCED CONCRETE						
900(1)c	Structural Concrete, Class A,3000 psi, 28 Days	9.92	11.76	cu.m.			
902(1)a1	Reinforcing Steel (Deformed) Grade 40	6.78	839.03	kgs.			
903(2)	Formworks and Falseworks	8.46	1.00	l.s.			
	TOTAL OF PART D	25.16					
	FINISHINGS AND OTHER CIVIL WORKS	2.00		<u> </u>			
	Septic Vault	3.89	1.00	l.s.			
1002(4)	Plumbing Fixtures  Cold Water Lines	1.15 0.27	1.00	L.S.			
1002(24)	Plumbing Works	0.27	1.00	L.S.			
1002(27) 1003(1)b1	4.5mm Fiber Cement Board on Metal Frame Ceiling	7.39	68.34	sq.m.			
1003(1)b1	Wall, Metal Cladding	0.99	7.86	sq.m.			
1003(2)7	Carpentry & Joinery Works	2.33	1.00	l.s.			
1008(1)a	Aluminum Glass Window (Sliding Type)	1.64	4.32	sq.m.			
1010(1)	Frames (Jambs, Sills, Head Transoms and Mullions)	0.46	6.00	set			
1010(2)b	Doors (Wood Panel)	1.58	2.73	sq.m.			
	Fabricated Metal Roofing Accessory (Gauge 26 (0.551 mm), Ridge Roll)	0.82	10.30	sq.m.			
1014(1)b2		6.33	80.77	sq.m.			
1018 (5)	Glazed Tiles	5.35	38.40	sq.m.			
1027(1)	Cement Plaster Finish	5.15	200.00	sq.m.			
1032(1)a	Painting Works, Masonry/Concrete	9.01	268.34	sq.m.			
1032(1)b	Painting Works, Wood	0.86	16.98	sq.m.			
1032(1)c	•	0.27	6.48	sq.m.			
1038(1)	Reflective Insulation	0.95	68.34	sq.m.			
1046(2)a1	CHB Non-Load Bearing(Including reinforcing Steel),100mm	8.94	109.49	sq.m.			
1047 (1)	Structural Steel	8.59	1.00	l.s.			
	TOTAL OF PART E	66.38					
PART	ELECTRICA L						
1100 (10)	Conduits, Boxes & Fittings (Conduit Works/Conduit Rough-In)	1.29	1.00	l.s.			
1101(33)	Wires and Wiring Devices	2.72	1.00	l.s.			
1102 (1)	Panelboard with Main & Branch Breakers	0.82	1.00	l.s.			
1103 (1)	Lighting Fixtures	1.43	1.00	l.s.			
	TOTAL OF PART F	6,26					
	GRAND TOTAL 100.00						

# 1 SUMMARY OF QUANTITIES O-1 SCALE NOT TO SCALE

PREPARED BY:

REPUBLIC OF THE PHILIPPINES
PROVINCIAL ENGINEER'S OFFICE
SAN AGUSTIN, DIGOS CITY, DAVAO DEL SUR

PROJECT TITLE:

CONSTRUCTION AND IMPROVEMENT OF
GREGORIO MATAS DISTRICT HOSPITAL
LOCATION: (GMDH)

POBLACION, KIBŁAWAN, DAVAO DEL SUR

ADNAN SHĀMIR L. PIÑOL ARCHITECT II JOSEPHIR GONZALES
ENGINEER - III
PLINNING AND PROGRAMMING DIV, HEAD

LEONERL MARCH P. SUARIO
PROVINCIAL ENGINEER

RECOMMENDING PPROVAL:


Speciagne/ YVONNE RONA CAGAS PROVINCIAL GOVERNOR

APPROVED BY:

0-1 12 1


SHEET NO.:

5. PRAYER ROOM

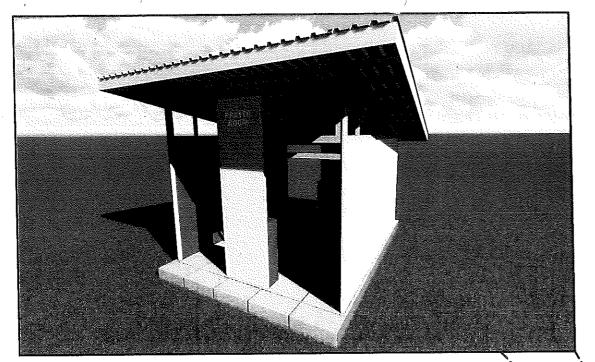


1 PERSPECTIVE

DNTS

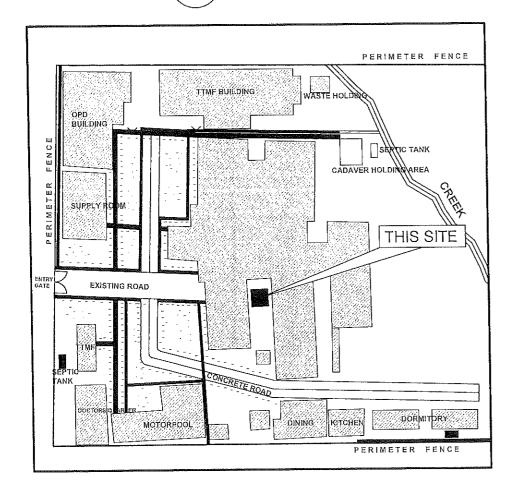

VICINITY MAP
DNTS

GREGORIO MATAS
DISTRICT
HOSPITAL

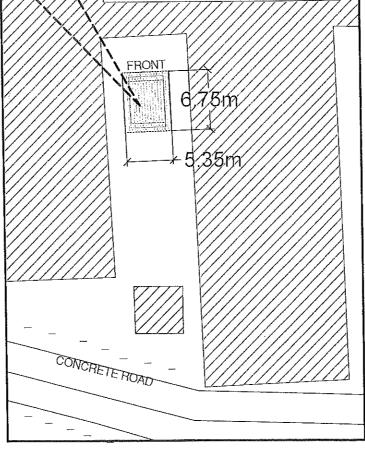

3 SITE DEVELOPMENT PLAN

RECOMMENDING APPROVAL:

APPROVED BY:

SHEET NO.:

REPUBLIC OF THE PHILIPPINES
PROVINCIAL ENGINEER'S OFFICE
SAN AGUSTIN, DIGOS CITY, DAVAO DEL SUR

CONSTRUCTION AND IMPROVEMENT OF GREGORIO MATAS DISTRICT HOSPITAL (GMDH)

POBLACION, KIBLAWAN, DAVAO DEL SUR

ESA JOY M. CAVALIDA
COS EMPLOYEE

JOSEPATA GONZALES

ENGINEER - III
PLANNING IND PROGRAMMINIS DIV. HEAD

**DNTS** 

LEONERL MARCH P. SUARIO
PROVINCIAL ENGINEER

TABLE OF CONTENTS

ARCHITECTURAL

PERSPECTIVE /
VICINITY MAP /
SITE DEVELOPMENT PLAN /
PROPOSED FLOOR PLAN /

REAR ELEVATION FRONT ELEVATION RIGHT SIDE ELEVATION LEFT SIDE ELEVATION

SECTION A .
SECTION B .
ROOF PLAN .
ROOF FRAMING PLAN

STRUCTURAL

NOTES

GENERAL CONSTRUCTION

GENERAL CONSTRUCTION

FOUNDATION PLAN

ISOMETRIC VIEW <

TRUSS DETAIL .
FACIA FRAME DETAIL .
DETAIL CONNECTION OF

TABLE ISOMETRIC VIEW -

ACRYLIC SIGNAGES .

SUMMARY OF QUANTITIES

OTHERS

CONNECTION OF ROOFING TO

ROOFING TO PURLIN

A.0

A-2

0.2

S-1

S-2

S-3

S-2

0.0

0-1

YVONNE RONA CAGAS
PROVINCIAL GOVERNOR

REPUBLIC OF THE PHILIPPINES
DEPARTMENT OF PUBLIC WORKS
AND HIGHWAYS

OFFICE OF THE BUILDING OFFICIAL

DISTRICT/CITY/MUNICIPALITY

LAND USE AND ZONING

LINE AND GRADE

ARCHITECTURAL


STRUCTURAL


SANITARY

ELECTRICAL

MECHANICAL

A-1 1 1

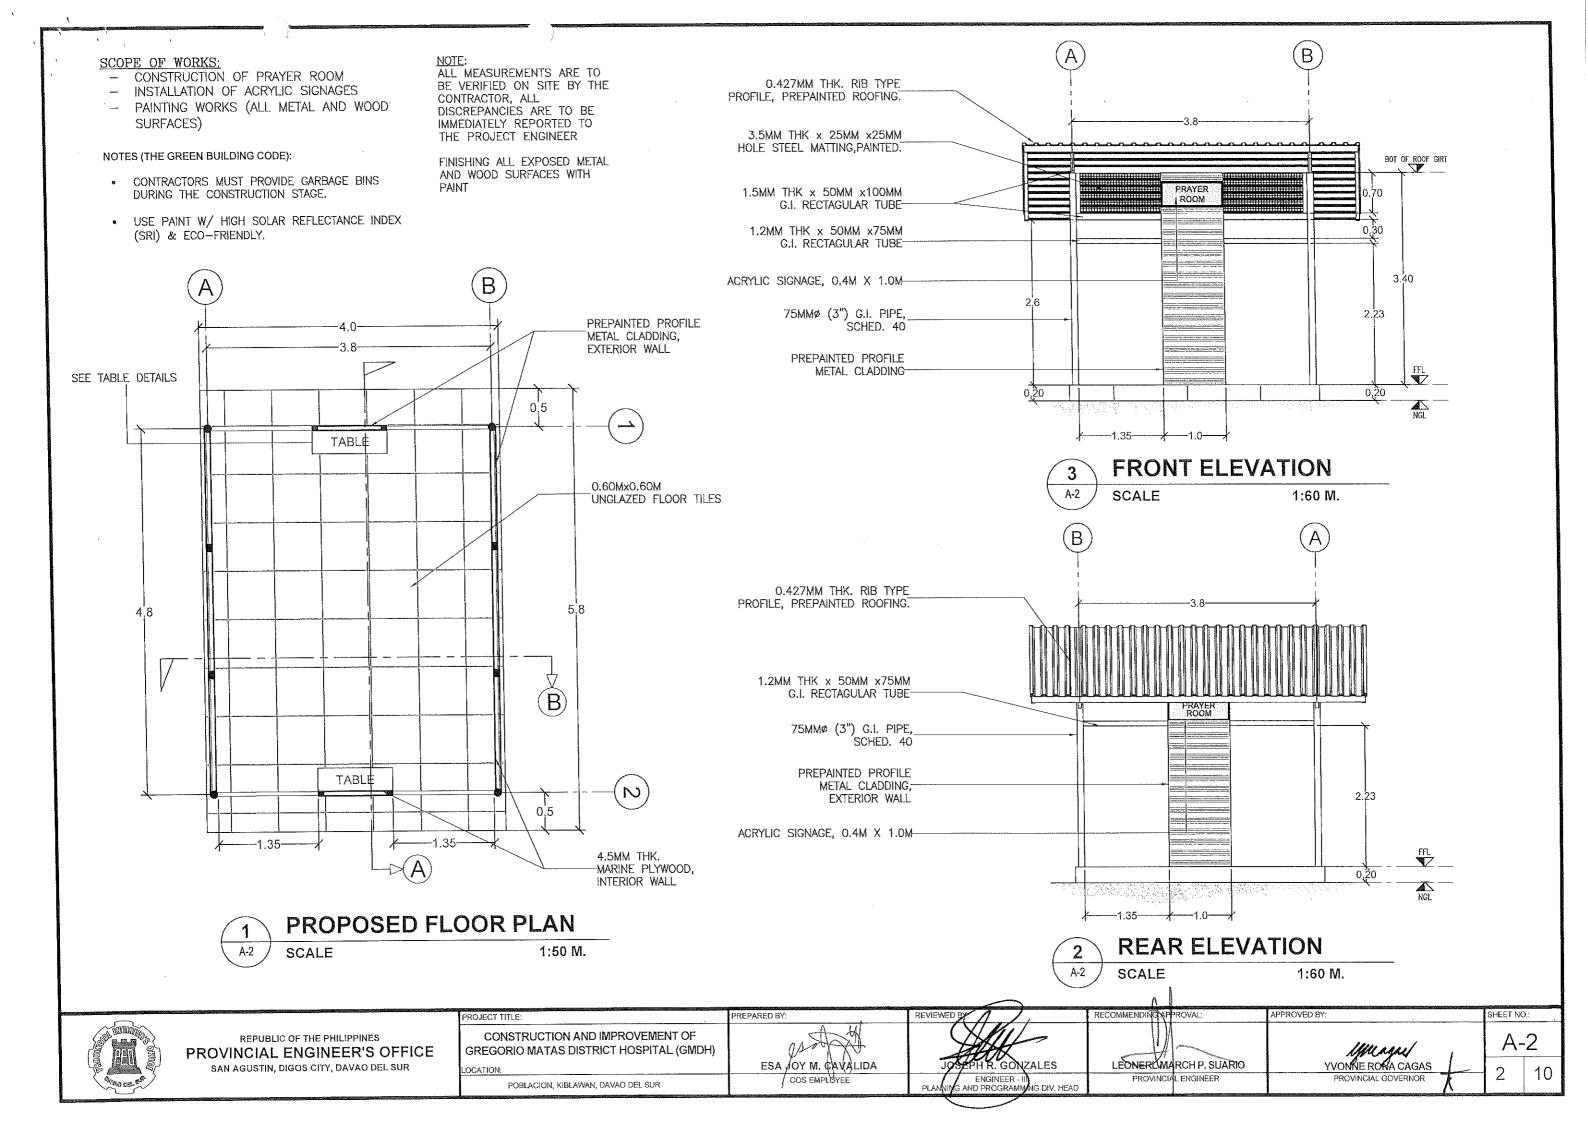

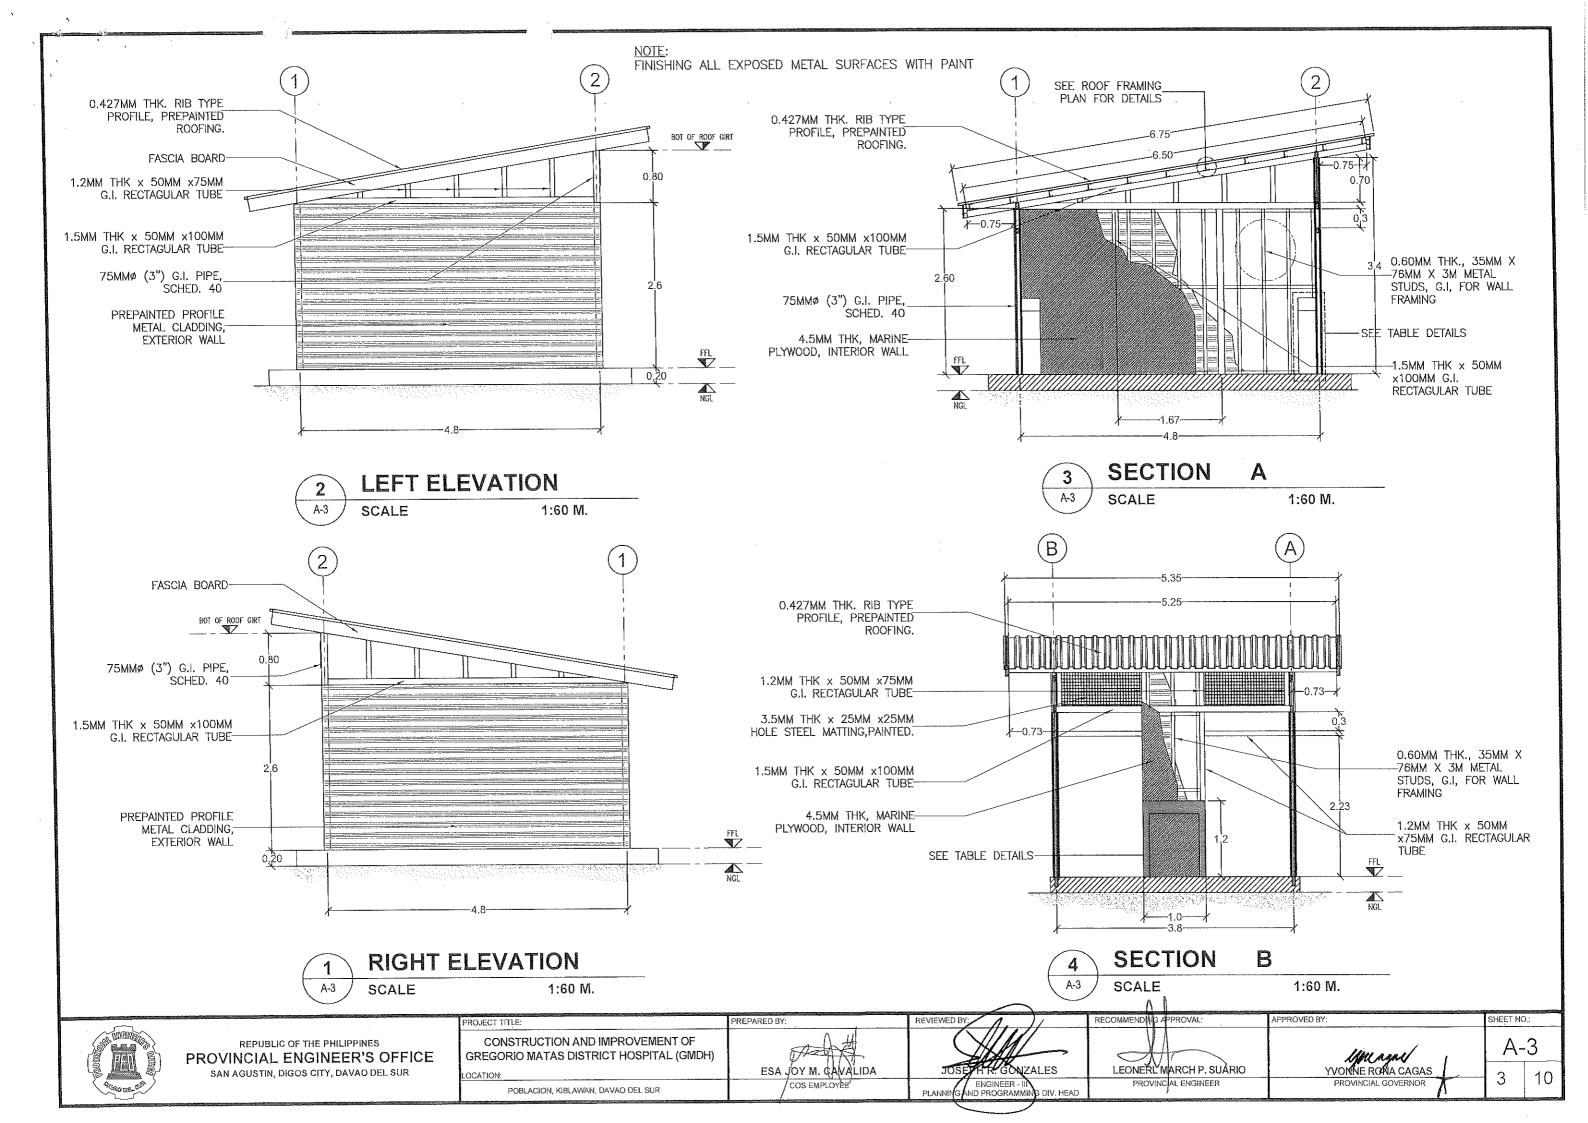

NOTE: ALL MEASUREMENTS ARE TO BE VERIFIED ON SITE BY THE CONTRACTOR, ALL DISCREPANCIES ARE TO BE IMMEDIATELY REPORTED TO THE PROJECT ENGINEER FINISHING ALL EXPOSED METAL SURFACES WITH PAINT 1.20MM THK.x50MMx 75MM LC PURLIN, W/ 4.0MM THK X 50MM X 50MM ANGLE BAR , PURLIN CLEAT. FASCIA BOARD ON \_1-1.2MM THK. 50MM X 75MM G.I. RECT. TUBE ON EVERY SIDE 0.427MM THK. RIB TYPE PROFILE, PREPAINTED ROOFING. В (B)-0.730.75 1.5MMx50MMX100MM \_10MMØ X 6M PLAIN ROUND BAR , SAG RODS 6.75 6.50 1.5MMx50MMX100MM (N  $\langle N \rangle$ 0.75 ROOF PLAN **ROOF FRAMING PLAN** SCALE 1:50 M. SCALE 1:50 M. PREPARED BY: PROJECT TITLE: REVIEWED BY RECOMMENDING APPROVAL: APPROVED BY: SHEET NO.; REPUBLIC OF THE PHILIPPINES CONSTRUCTION AND IMPROVEMENT OF A-4 GREGORIO MATAS DISTRICT HOSPITAL (GMDH) PROVINCIAL ENGINEER'S OFFICE SHIL AGAS, YVOMNE ROMA CAGAS, ESAJOY M. CAVALIDA SAN AGUSTIN, DIGOS CITY, DAVAO DEL SUR LEONER MARCH P. SUARIO COS EMPLOYEE ENGINEER - 111 NG AND PROGRAMMIN PROVINCIAL ENGINEER POBLACION, KIBLAWAN, DAVAO DEL SUR

#### **GENERAL NOTES**

#### 1.0 STANDARDS AND REFERENCES

THE FOLLOWING SHALL GOVERN THE DESIGN FABRICATION AND CONSTRUCTION OF THE PROJECT. 1.1 NATIONAL STRUCTURAL CODE OF THE PHILIPPINES (N.S.C.P 2015) VOL. 1, SEVENTH EDITION. 1.2 SPECIFICATIONS SHALL BE IN ACCORDANCE WITH THE DPWH STANDARD SPECIFICATIONS FOR PUBLIC WORKS STRUCTURES VOLUME III, 2019 EDITION.

4.80 kPa

#### 2.0 DESIGN CRITERIA

#### 2.1 LOADINGS

#### A. DE.

DEAD LOAD	
CONCRETE	23.56 kN/m³
STEEL	76.93 kN/m <sup>3</sup>
150 mm THK, CHB WALL	2.73 kPa
100 mm THK. CHB WALL	2.11 kPa
LIVE LOAD	
ROOF	1.00 kPa
TOILETS	1.90 kPa
CORRIDORS ABOVE, STAIRS	3.80 kPa

#### C. WIND LOAD

CORRIDORS ON GROUND

BUILDING CATEGORY = 1 (ESSENTIAL FACILITIES)

EXPOSURE = D (FLAT, UNOBSTRUCTED AREAS AND WATER SURFACES) MAXIMUM WIND VELOCITY, V = 340 KPH

(DESIGN WIND PRESSURE) P = ah ((GCpf)-(GCpi)) WHERE: oh = VELOCITY PRESSURE (kPa)

GCpf = EXTERNAL PRESSURE COEFFICIENT GCof = INTERNAL PRESSURE COEFFICIENT

#### D. SEISMIC LOAD

 $V = \frac{Cv|}{RT}W$ 

(DESIGN BASE SHEAR)

Vmin = 0.11 CalW  $Vmln = \frac{0.80 \text{ ZNvl}}{2} W \text{ (ZONE 4)}$ 

WHERE: W = TOTAL DEAD LOAD T = NATURAL PERIOD = Ct(h) WHERE: C = NUMERICAL COEFFICIENT h = BUILDING HEIGHT I = IMPORTANCE FACTOR = 1.50 R = NUMERICAL FACTOR = 8.50 SEISMIC COEFFICIENT Cv = 0.44 Nv Ca = 0.64 Nv NEAR SOURCE FACTOR (5 km) Nv = 1.6

> Z = SEISMIC ZONE = 0.40 (ZONE 4) S = SOIL TYPE = D

#### 22 DESIGN STRESSES

A. CONCRETE COMPRESSIVE STRENGTH @ 28 DAYS: a. FOOTINGS, COLUMNS, BEAMS AND SLABS

fc = 20.7 MPa (3.000 osi rc = 17.5 MPa (2,500 psi)

b. SLAB ON FILL B. REINFORCING STEEL BARS a. FOR BARS 16mm AND GREATER (INTERMEDIATE GRADE DEFORMED BAR)

COLD FORMED LIGHT

fy = 275 MPa (40,000 psi) fy = 230 MPa (33,000 psi)

b. FOR BARS LESS THAN 16mm (STRUCTURAL GRADE DEFORMED BAR) C. STRUCTURAL STEEL ASTM-A36 FOR TRUSSES, BRACINGS, & STRUTS D. PURLINS

(y = 248 MPa (36,000 psi)

E. MASONRY UNIT (CHB) NON - LOADING BEARING CHB WALLS G. STRUCTURAL BOLTS ASTM- A307

fm' = 3.45 MPa (500 psi) E - 60XX ELECTRODE a. Ft = 96,60 mPa (14, 000 psi) b. Fv= 69.00 mPa (10, 000 psi)

fy = 248 MPa (36,000 psi)

3.0 IN THE INTERPRETATION OF THE DRAWING, INDICATED DIMENSIONS SHALL GOVERN. DISTANCES AND SIZES SHALL NOT BE SCALED FOR CONSTRUCTIONS PURPOSES

4.0 IN REFERENCES TO OTHER DRAWINGS, SEE ARCHITECTURAL DRAWINGS FOR DEPRESSIONS IN FLOOR SLABS, OPENINGS IN THE WALLS AND SLABS, INTERIOR PARTITIONS, LOCATIONS OF DRAINS ETC.

5.0 IN CASE OF DISCREPANCIES AS TO THE LAYOUT, DIMENSIONS AND ELEVATIONS BETWEEN THE STRUCTURAL PLANS AND ARCHITECTURAL DRAWINGS, THE CONTRACTORS SHALL NOTIFY BOTH THE STRUCTURAL ENGINEER AND ARCHITECTS.

6.0 ALL CONCRETE WORKS AND CONCRETE REINFORCEMENTS SHALL BE DONE IN ACCORDANCE WITH THE ACI,318 95 BUILDING CODE REQUIREMENT AND ALL STRUCTURAL STEEL WORKS ACCORDING WITH THE AISC SPECIFICATION (9TH EDITION) SO FAR AS THEY DO NOT CONFLICT WITH THE LOCAL BUILDING CODE REQUIREMENT.

7.0 ACI REFERS TO AMERICAN CONCRETE INSTITUTE, AISC REFERS TO AMERICAN INSTITUTE OF STEEL CONSTRUCTION AND ASTM REFERS TO AMERICAN SOCIETY FOR TESTING MATERIALS,

8.0 CONSTRUCTION NOTES AND TYPICAL DETAILS APPLY TO ALL DRAWINGS UNLESS OTHERWISE SHOWN OR NOTED, MODIFY TYPICAL DETAILS AS DIRECTED TO MEET SPECIAL CONDITIONS.

9.0 SHOP DRAWING WITH ERECTION AND PLACING DIAGRAMS OF ALL STRUCTURAL STEELS, MISCELLANEOUS IRON, PRE-CAST CONCRETE, ETC. SHALL BE SUBMITTED FOR ENGINEERS APPROVAL BEFORE FABRICATION.

10. CONTRACTOR SHALL NOTE AND PROVIDE ALL MISCELLANEOUS CURBS, SILLS, STOOLS EQUIPMENT AND MECHANICAL BASES THAT ARE REQUIRED BY THE ARCHITECTURAL, ELECTRICAL AND MECHANICAL DRAWINGS.

11. ALL RESULTS OF THE MATERIAL TESTING FOR CONCRETE, REINFORCING BARS & STRUCTURAL STEEL MUST BE NOTED & APPROVED BY THE MATERIALS ENGINEER/STRUCTURAL DESIGNER.

# GENERAL CONSTRUCTION NOTES

1. USE TYPE 1 PORTLAND CEMENT FOR STRUCTURAL CONCRETE.

2. ALL CONCRETE SHALL DEVELOP A MIN, COMPRESSIVE STRENGTH AT THE END OF TWENTY EIGHT (28) DAYS W/ CORRESPONDING MAXIMUM SIZE AGGREGATE & SLUMP AS FOLLOWS.

LOCATION	28 DAYS STRENGTH	MAX, SIZE OF AGGREGATE	MAX SLU
ALL OTHERS, INCLUDING	3000 PSI (20.7 MPa)	20 mm	100mm
SUSPENDED SLABS COLUMNS BEAMS ,SLABS SLAB ON FILL	3000 PSI (20.7 MPa) 3000 PSI (20.7 MPa) 2500 PSI (17.5 MPa)	20 mm 20 mm 20 mm	100mm 100mm 100mm
CIACO SELICIMENTAL MATERIALE	DETE COVICE BOD DEINICODO	INC STEEL AS COLLOW	e e

IUM CONCRETE COVER FOR REINFORGING STEEL AS FOLLOW SUSPENDED SLABS -SLAB ON GRADE 25mm WALLS ABOVE THE GRADE BEAM STIRRUPS AND COLUMN TIES 40mm WHERE CONCRETE IS EXPOSED TO EARTH BUT POURED AGAINST FORMS 50mm WHERE CONCRETE IS DEPOSITED DIRECTLY AGAINST EARTH

4. CONCRETE SHALL BE DEPOSITED IN ITS FINAL POSITION WITHOUT SEGREGATION. RE-HANDLING OR PLACING SHALL BE DONE PREFERABLY WITH BUGGIES, BUCKETS OR WHEELBARROWS, NO CHUTES WILL BE ALLOWED EXCEPT TO TRANSFER CONCRETE FROM HOPPERS TO BUGGIES, WHEFI BARROWS OR BUCKETS IN WHICH CASE THEY SHALL NOT EXCEED SIX (6) METERS IN AGGREGATE LENGTH.

5. NO DEPOSITING OF CONCRETE SHALL BE ALLOWED WITHOUT THE USE OF VIBRATORS UNLESS AUTHORIZED IN WRITING DESIGNER AND ONLY FOR UNUSUAL CONDITIONS WHERE VIBRATIONS ARE EXTREMELY DIFFICULT TO ACCOMPLISH.

6. ALL ANCHOR BOLTS, DOWELS, AND OTHER INSERTS SHALL BE PROPERLY POSITIONED & SECURED IN PLACE PRIOR TO PLACING OF CONCRETE.

 ALL CONCRETE SHALL BE KEPT MOST FOR A MINIMUM OF SEVEN CONSECUTIVE DAYS IMMEDIATELY AFTER POURING BY THE USE O WET BURLAP, FOG SPRAYING, CURING COMPOUNDS OR OTHER APPROVED METHODS.

8. STRIPPING OF FORMS AND SHORES: FOUNDATION SUSPENDED SLAB EXCEPT WHEN \_ 8 DAYS ADDITIONAL LOADS ARE IMPOSED 21 DAYS WALLS 14 DAYS REAMS 21 DAYS COLUMNS

9. THE CONTRACTOR SHALL SUBMIT THE SCHEDULE OF POURING AND THE LOCATION OF THE CONSTRUCTION JOINTS TO THE STRUCTURAL ENGINEER AT LEAST (4) DAYS PRIOR TO THE POLIRING FOR APPROVAL

10. THE CONTRACTOR SHALL FURNISH AND MAINTAIN ADEQUATE FORMS AND SHORINGS UNTIL THE CONCRETE MEMBERS HAVE ATTAINED THEIR WORKING CONDITION AND STRENGTH.

#### NOTES ON FOOTINGS

 FOOTINGS ARE DESIGNED FOR AN ALLOWANCE SOIL BEARING PRESSURE OF 96 KPa (2000psf) CONTRACTOR SHALL REPORT TO THE ENGINEER, IN WRITING, THE ACTUAL SOIL CONDITIONS UNCOVERED AND CONFIRM ACTUAL BEARING CAPACITY OF SOIL BEFORE DEPOSITING CONCRETE. 2. FOOTING SHALL REST AT LEAST 1500mm BELOW NATURAL GRADE LINE UNLESS OTHERWISE

INDICATED IN PLANS, NO FOOTING SHALL REST ON FILL 3. MINIMUM CONCRETE PROTECTION FOR REINFORCEMENT SHALL BE 75mm CLEAR FOR CONCRETE

DEPOSITED THE GROUND AND 50mm FOR CONCRETE DEPOSITED AGAINST A FORMWORK. 4. IN CASES WHERE THE SOIL CONDITION IS SUCH THAT THE MINIMUM ALLOWABLE SOIL PRESSURE OF 96KP8 (2000 pst) CAN NOT BE ATTAINED AT A PRACTICAL DEPTHS THE USE OF MICROPILES, BORED PILES, OR DRIVEN PILES MAY BE ADOPTED IN LIEU OF STANDARD ISOLATED FOOTINGS.

### NOTES ON REINFORCEMENT

1. UNLESS OTHERWISE NOTED IN PLANS, THE YIELD STRENGTH OF REINFORCING BARS SHALL BE: \_ fv = 275 MPa (40,000 osi) FOOTINGS . FOOTING BEAMS AND GIRDERS \_\_\_\_ B. COLUMNS AND SHEAR WALLS ...  $f_V = 275 \text{ MPa} (40.000 \text{ psi})$ BEAMS AND GIRDER fy = 275 MPa ( 40,000 psi


D. NON-LOAD BEARING WALL PARTITIONS , BEDDED SLABS , FLOOR & ROOF SLABS \_ fy = 275 MPa ( 40,000 psi) PARAPETS .CATCH BASIN.SIDE WALK 2 ALL REINFORCING BARS SIZE 10mm OR LARGER SHALL BE DEFORMED IN ACCORDANCE WITH THE ASTM A-706

BARS SMALLER THAN 10mm MAY BE PLAIN. 3. SPLICES SHALL BE SECURELY WIRED TOGETHER & SHALL LAP OR EXTEND IN ACCORDANCE W/TABLE B

(TABLE OF LAP SPLICE & ANCHORAGE LENGTH) UNLESS OTHERWISE SHOWN ON DRAWINGS, SPLICES SHALL BE STAGGERED WHENEVER POSSIBLE

#### NOTES ON CONCRETE SLABS

1. ALL SLAB REINFORCEMENTS SHALL BE 20 mm CLEAR MINIMUM FROM BOTTOM AND FROM THE TOP OF SLAB.
2. UNLESS OTHERWISE SHOWN, REINFORCEMENT IN CONTINUOUS ELEVATED SLAB SHALL BE CUT AS FOLLOWS:

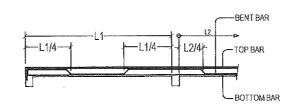


3. IF SLABS AR F REINFORCED BOTHWAYS BARS ALONG THE SHORTER SPAN SHALL BE PLACED. BELOW THOSE ALONE THE LONG SPAN AT THE CENTER AND OVER THE LONGER SPAN FOR REINFORCING BARS NEAR THE SUPPORTS. THE SPACING OF THE BARS AT THE COLUMN STRIPS SHALL NOT BE MORE THAN ONE AND A HALF ( 1  $\frac{1}{2}$  ) SLAB THICKNESS.

4. TEMPERATURE BARS FOR SLAB SHALL BE GENERALLY PLACED NEAR THE FACE IN TENSION AND SHALL NOT BE LESS THAN 0.0025 X GROSS-SECTIONAL AREA (Ag) OF THE SLAB, ( SEE SCHEDULE BELOW)


SOLIEDOE	E OF MINIMUM SLAB REINFORCEMENT
	MINIMUM TEMPERATURE BARS
100 mm	10mm Ø @ 250mm EACH WAY
125 mm	10mm Ø @ 250mm EACH WAY
150 mm	10mm Ø @ 250mm EACH WAY
175 mm	10mm Ø @ 250mm EACH WAY
200 mm	10mm Ø @ 250mm EACH WAY

- 5. UNLESS OTHERWISE NOTED IN THE PLANS ALL BEDDED SLABS SHALL BE REINFORCED WITH 10mm Ø AT 250mm O.C. EACH WAY TO CENTER OF SLAB AND CONSTRUCTION JOINTS FOR SAME SHALL NOT RELESS THAN 3.65 METER APART
- 6. PROVIDE EXTRA REINFORCEMENTS FOR CORNER SLAB (TWO ADJACENT DISCONTINUES EDGES)
- 7, CONCRETE SLAB REINFORCEMENT BE PROPERLY SUPPORTED WITH 10mm STEEL CHAIR OR APPROVED EQUIVALENT SPACED AT 1.0 METER ON CENTER BOTHWAYS

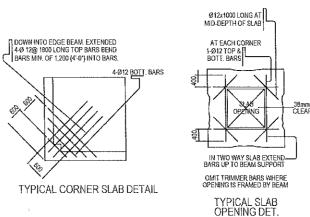


NOTES ON COLUMNS

- 1. PROVIDE EXTRA SETS OF TIES AT 100 O.C. FOR TIED COLUMN REINFORCEMENT ABOVE AND BELOW BEAM-COLUMN CONNECTIONS FOR A DISTANCE FROM FACE OF CONNECTION EQUAL TO GREATER OF THE OVERALL THICKNESS OF COLUMN, 1/6 THE CLEAR HEIGHT OF
- 2. COLUMN TIES SHALL BE PROTECTED EVERYWHERE BY A COVERING OF CONCRETE CAST MONOLITHICALLY WIT THE CORE WITH A MINIMUM THICKNESS OF 40mm AND NOT LESS THAN 40 TIMES THE MAXIMUM SIZE OF COARSE AGGREGATE IN MILLIMETERS.
- 3. WHERE COLUMNS CHANGE IN SIZE , VERTICAL REINFORCEMENT SHALL BE OFFSET AT A SLOPE MONOLITHICALLY WITH THE CORE WITH MINIMUM THICKNESS OF 40mm AND NOT LESS THAN 40 TIMES THE MAXIMUM SIZE COARSE AGGREGATE IN MILLIMETERS
- 4. UNLESS OTHERWISE INDICATED IN THE PLANS, LAP SPLICES FOR VERTICAL COLUMN REINFORCEMENT SHALL BE MADE WITHIN THE CENTER HALF OF COLUMN HEIGHT, AND THE SPLICE LENGTH SHALL BE LESS THAN 40 BAR DIAMETERS, WELDING OR APPROVED MECHANICAL DEVICES MAY BE USED PROVIDED THAT NOT MORE THAN ALTERNATE BARS ARE WELDED OR MECHANICALLY SPLICED AT ANY LEVEL AND THE VERTICAL DISTANCES BETWEEN THESE WELDS OR SPLICES OF ADJACENT BARS IS NOT LESS THAN 600mm.

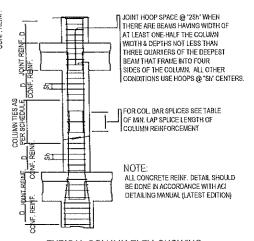


TYPICAL COLUMN ELEV. SHOWING DOWELS AND TIES SPACING

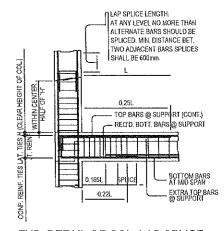

TYP. DETAIL OF COL. LAP SPLICE & EXT. GIRDER TO COL. CONNECT.

#### NOTES ON BEAMS AND GIRDERS

- 1. UNLESS, OTHERWISE NOTED IN PLANS , CAMBER ALL BEAMS AND GIRDER AT LEAST 6mm@ FOR EVERY 4.50 M OF SPAN EXCEPT CANTILEVERS FOR WHICH THE CAMBER SHALL BE AS NOTED IN PLANS OR AS ORDERED BY THE ENGINEER BUT IN NO CASE LESS THAN 20 mm FOR EVERY 3.0 M OF FREE SPAN
- 2. TYPICAL BARS BENDING AND CUTTING DETAILS FOR BEAMS SHALL BE AS

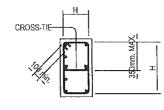

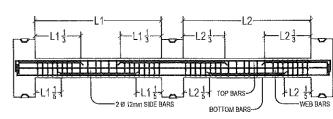


FIGURE B-1



REPUBLIC OF THE PHILIPPINES

PROVINCIAL ENGINEER'S OFFICE SAN AGUSTIN, DIGOS CITY, DAVAO DEL SUR

ROJECT TITLE: CONSTRUCTION AND IMPROVEMENT OF GREGORIO MATAS DISTRICT HOSPITAL (GMDH)

POBLACION, KIBLAWAN, DAVAO DEL SUR

PREPARED BY:

ESA JÓY M. QAVÁLIDA COS EMPLOYEE

REVIEWED BY Ŕ, GONZALES NG DIV HEAD RECOMMENDIÑO APPROVAL LEONERL MARCH P. SUARIO PROVINCIAL ENGINEER

YVONNE ROÑA CAGAS PROVINCIAL GOVERNOR

APPROVED BY

5


SHEET NO

# GENERAL CONSTRUCTION NOTES


TABLE		TABLE 'A' NSION BAR E & ANCHOI	S RAGE LENGTH (	mm)
BAR SIZES	(c' = 20.7 M	Pa(300psi)	fc'= 27.6 MPa	(4000psi)
(DEFCRUED XM)	EMBEDMENT	LAPPED	EMBEDMENT	LAPPED
Ø10	300	300	300	360
Ø12	300	360	300	300
Ø16	360	400	300	480
Ø20	400	550	350	500
Ø25	600	£00	550	750
Ø28	750	1000	650	850
Ø32	950	1300	850	1100

TABLE		PRESSION B E & ANCHO	ars Rage Length (	mm)			
BAR SIZES fo'= 20.7/MPa(300psi) fo'= 27.6 MPa (4000psi)							
(GEFORMED M.VI)	EMBEDMENT	LAPPED	EMBEDMENT	LAPPED			
Ø10	225	300	200	300			
Ø12	275	300	250	300			
Ø16	350	400	325	480			
Ø20	450	509	475	500			
Ø25	550	625	550	525			
£328	625	675	625	675			
Ø32	700	775	700	775			

- 1 TOP PLAIN BARS MILITIPLY VALUE BY 2 2. NOT MORE THAN 33% OF THE BARS SHALL BE SPLICED WITHIN THE REQUIRED LAP LENGT
- 3. IF THE BEAM REINFORCING BARS END IN A WALL, THE CLEAR DISTANCE FROM THE BAR TO THE FARTHER FACE OF THE WALL IS NOT LESS THAN 25mm. EMBEDMENT LENGTH SHALL BE SHOWN IN A TABLE 'A' FOR TENSION BARS AND TABLE 'B' FOR COMPRESSION BARS UNLESS UNLESS SPECIFIED IN PLAN, TOP BARS AND SHALL NOT BE SPLICED WITHIN THE COLUMN OR TWO STIRRUPS SHALL BE PROVED AT ALL SPLICES.
- 4. IF THERE ARE TWO OR MORE LAYERS OF REINFORCING BARS, USED 25mm BAR SEPARATORS SPACED AT 1.0M ON CENTER ON NO CASE SHALL THERE BE THAN TWO (2) SEPARATORS BETWEEN LAYERS OF BARS
- 5. MINIMUM CONCRETE PROTECTION FOR REINFORCING BARS OR STEEL SHAPES SHALL BE AS SHOWN IN FIGURE B-2

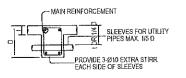

TYP, DET, FOR SLEEVES THRU CONCRETE BEAM FIG. B-2

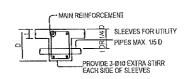

TYP, DET, FOR SLEEVES THRU CONCRETE BEAM FIG. B-3

- 6, WHEN A BEAM CROSSES A GIRDER, REST BEAM ON TOP OF GIRDER BARS, BEAM REINFORCING BARS SHALL BE SYMMETRICAL ABOUT THE CENTER LINE WHENEVER POSSIBLE.
- 7. GENERALLY, NO SPLICES SHALL BE PERMITTED AT POINTS WHERE CRITICAL BENDING STRESSES OCCUR, SPLICES WHERE SO PERMITTED SHALL BE INDICATED IN TABLE 'A' AND 'B'. WELDED SPLICES SHALL DEVELOP IN TENSION AT LEAST 125% OF THE SPLICED YIELD STRENGTH OF THE BAR NOT MORE THAN 50% OF THE BARS AT ANY ONE SECTION IS ALLOWED TO BE SPLICED THEREIN.


### NOTES ON CONCRETE HOLLOW BLOCKS WALLS


- 1, UNLESS OTHERWISE SHOWN IN PLANS ALL CONCRETE HOLLOW BLOCKS AND CERAMIC BLOCKS SHALL BE REINFORCED AS SHOWN IN THE SCHEDULE OF CONCRETE HOLLOW BLOCKS AND CERAMIC BLOCK REINFORCEMENT
- 2, PROVIDE 150mm x 300mm STIFFENER COLUMN REINFORCED WITH 4-12mm WITH 10mm Ø TIES AT 150mm ON CENTER WHERE CONCRETE HOLLOW BLOCK TERMINATES AND AT EVERY 3.0M LENGTH OF CONCRETE HOLLOW BLOCK WALLS UNLESS NOTED IN STRUCTURAL PLANS.


BLOCK THICKNESS	REINFORCE	MENT	NOTES
	HORIZONTAL	LAPPED	A. MINIMUM LAPS AT SPLICE≍ 0.25 M
100 mm	10mm Ø EVERY 3RD LEVEL	10mm Ø @ 600mm O.C.	B. PROVIDE RIGHT ANGLED REINFORCEMENT AT CORNERS 0.92 m LONG
125 mm	10mm Ø EVERY 3RD LEVEL	10mm Ø @ 600mm O.C.	C.WHERE CHB OR CER. BLK. WALL DOWELS
150mm	10mm Ø EVERY 3RD LEVEL	10mm Ø @ 600mm O.C.	WITH THE SAME SIZE AS VER. OR HOR. REINFORCEMENT SHALL BE PROVIDED
200 mm	12mm Ø EVERY 3RD LEVEL	10mm Ø @ 600mm O.C.	TEM ONGEWENT OFFICE DE TROVIDED


#### REINFORCING CONCRETE LINTEL BEAMS IN CONCRETE BLOCK WALLS

CLEAR	TOTAL	MIN.	HEIGHT OF	F	REINFOR	CEMENT
SPAN (L)	1.ENGTH (L+0.401A)	fo' (MPa)	LINTEL (mm)	BOTTOM	TOP	STIRRUPS
1,20 1년	1,60 %		200	1-910	1-610	Ø\$ mm @ 209mm.
1.50 3.4	1.90 M	140	200	1-610	1-6116	05 eran @ 200mm
1,601,1	2.2014		200	1-012	1-2410	Ø6 mm @ 200mm
2.10 M	2 50 M		250	1-012	1-1010	Ø6 am @ 280mm
2.40 M	2.90 M	17.0	250	1-012	1-6310	26 ாக @ 200mm
2.70 M	3,10 M		250	1-Ø16	1-Ø12	Ø10am @ 200mm
3.00 M	3.40 M		300	1-016	1-Ø12	Ø \$0mm @ 200mm
3 30 f.L	3.70 M	20.0	300	1-Ø18	1-Ø12	040mm @ 200ava
3.60 84	4.00 M		300	1-2720	1-5512	Ø10 rvn @ 200m/n

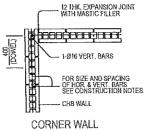

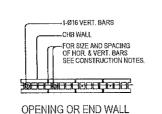

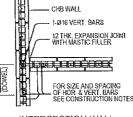


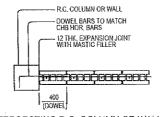


INTERSECTION WALL


INTERSECTING R.C. COLUMN OR WALL


#### TYPICAL CONNECTION DETAIL OF MASONRY WALL

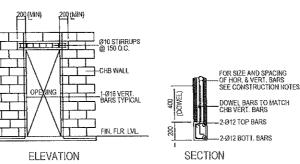


TYP, DET, OF LINTEL BEAM AT CHB WALL OPENING

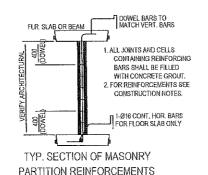


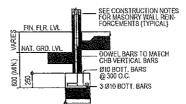

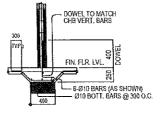


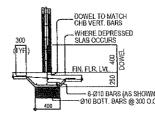

TYPICAL CHB FOOTING DETAILS (WHERE APPLICABLE)

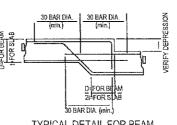

TYPICAL DETAIL FOR BEAM OR SLAB CHANGE SOFFIT

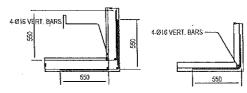

TYPICAL CONNECTION DETAIL OF R.C. WALL AT CORNERS

#### NOTES ON WELDS

- 1. USE E60xx ELECTRODES FOR ALL MEMBERS WELDED.
- 2. WELDS SHALL DEVELOP THE FULL STRENGTH OF MEMBERS JOINED UNLESS OTHERWISE SHOWN OR DETAILED IN THE DRAWINGS.

#### NOTES ON STRUCTURAL STEEL


- 1, STRUCTURAL STEEL TO BE USED FOR FABRICATION AND ERECTION OF THIS STRUCTURE SHALL COMPLY WITH ALL THE PERTINENT PROVISION OF AISC SPECIFICATION FOR THE DESIGN, FABRICATION AND ERECTION OF STRUCTURAL STEEL FOR BUILDING LATEST EDITION.
- 2. ALL STRUCTURAL STEEL SHAPES SHALL CONFORM TO ASTM A36 STRUCTURAL STEEL UNLESS OTHERWISE INDICATED.
- 3. ALL WELDED CONNECTIONS SHALL DEVELOP THE FULL STRENGTH OF THE MEMBERS CONNECTED.
- 4. UNLESS OTHERWISE SPECIFIED ALL WELDING RODS SHALL CONFORM WITH
- 5, ALL BOLTS USED UNLESS OTHERWISE SPECIFIED SHALL BE ASTM A 307 BOLTS

#### NOTES ON EMBEDDED PIPES

- 1, ALL EMBEDDED PIPES FOR UTILITIES ETC. THAT PASS THRU BEAMS SHALL NOT EXCEED 100mm IN DIAMETER OR 1/3 BEAM DEPTH WHICHEVER IS LESS, UNLESS OTHERWISE APPROVED IN WRITING BY THE STRUCTURAL ENGINEER.
- 2. NO PIPES SHALL BE ALLOWED TO PASS THRU BEAMS VERTICALLY. 3, NO PIPES SHALL BE EMBEDDED IN COLUMNS.

## NOTES ON CONSTRUCTION JOINTS IN CONCRETE

1, WHERE A CONSTRUCTION JOINT IS TO BE MADE, THE SURFACE OF CONCRETE SHALL BE CLEANED AND ALL LAITANCE AND STANDING WATER REMOVED SHEAR KEY SHALL BE PROVIDE AT THE JOINT.

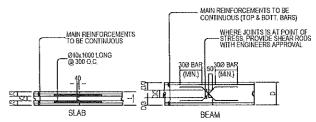

TYPICAL SLAB & BEAM CONSTRUCTION JOINT DET.


#### NOTES ON CONCRETE WALLS

1, ALL WALLS SHALL BE REINFORCED ACCORDING TO THE FOLLOWING SCHEDULE OF WALL REINFORCEMENT UNLESS OTHERWISE INDICATED IN THE PLANS

[	WALL		REINFORCEMENT		VERTICAL
ļ	THICKNESS	HORIZONTAL	VERTICAL	REMARKS	SECTION
		Ø10mm @ 250mm O.C.			VER BARS
ĺ	125mm	Ø10mm @ 200mm O.C.	Ø10mm @ 250mm O.C.	AT CENTERS VERTICAL	VFR HARS
- [	150mm	Ø12mm @ 250mm O.C.	Ø12mm @ 300mm O.C.	BARS STAGGERED OUT	HOR BARS

REINFORCING BARS SHALL HAVE 25mm CLEAR CONCRETE COVER FROM FACE OF WALL EXCEPT FOR WALLS IN CONTACT WITH THE GROUND WHERE A MINIMUM OF 60mm SHALL BE PROVIDED AND FOR EXPOSED FACES OF FORMED WALLS WHERE THE MINIMUM SHALL BE 50mm CLEAR

- 2. CARRY VERTICAL BARS AT LEAST 60mm ABOVE FLOOR LEVEL TO PROVIDE FOR SPLICES WHEN NECESSARY STOP AT 50mm BELOW TOP SLAB OR SOLID BAND WHERE THE WALL ENDS VERTICAL AND HORIZONTAL BARS SHALL BE SPLICED BY LAPPING A DISTANCE EQUAL TO 30 DIAMETERS AND WIRED SECURELY WITH 16 G.I. WIRE PROVIDED THAT SPLICES IN ADJACENT BARS ARE STAGGERED AT LEAST 1.50M O.C.
- 3. UNLESS OTHERWISE NOTED IN THE PLANS, ALL OPENINGS IN WALLS 250mm OR THICKER SHALL BE REINFORCED AROUND WITH 2-20mm/0 BARS\_FOR 225mm\_200mm\_175mm\_150mm THICK WALLS, USE 2-16mm/0\_FOR 125mm AND 100mm THICK WALLS, USE 2-12mmØ BARS, ALL WALLS SPANNING SHALL HAVE VERTICAL REINFORCEMENT BENT A U-FORM LIKE STIRRUPS AND SPACED ACCORDING TO THE SCHEDULE UNLESS OTHERWISE NOTED.

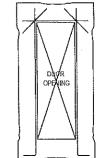

PPROVED BY:

# + D+12db

1. ALL REINFORCEMENT SHALL BE BENT COLD UNLESS

2. AS SHOWN IN THE DESIGN DRAWINGS OR PERMITTED BY THE STRUCTURAL ENGINEER.


3. TIES & CLOSE STIRRUPS MUST BE AT 135.

OTHERWISE PERMITTED BY THE STRUCTURAL ENGINEER

NOTES ON STIRRUPS

4db <del>bR 6</del>5mm


BAR SIZE	DIAVETER	160*1	100k	89. HOOK
(DEFORMED)	(mm)	D+2db	L	L
10 mm Ø	60	75	125	150
12 m m Ø	75	100	150	200
16 កកាស	95	125	175	250
20 mm Ø	115	150	200	309
25 m = 60	150	200	230	459
28 mm Ø	240	300	350	550
32 mm Ø	300	335	450	600

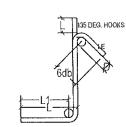

	STIRRUP AND (ALL	THE TIE H GRADES)	OOKS		
BAR SIZE	DIAVETER	IBO, HOOK		60, HOOK	
(DELOSWED)	(mm)	0+2db	1.	L	
10 mm Ø	48	125	85	100	
12 mm Ø	5D	165	115	115	
16 mm Ø	65	200	140	150	
20 rsm Ø	115	300	165	350	
32 mm Ø	150	335	230	405	

PROVIDE THESE ADDITIONAL BARS FOR ALL OPENINGS PLUS BARS (NOT SHOWN) PARALLEL TO SIDE OF OPENING EQUAL TO THE NUMBER OF TERMINATED BARS AT OPENING

SEE ARCHITECTURAL & MECHANICAL PLANS FOR SLAB OPENING LOCATION.

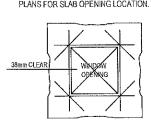

TYP. EXTERIOR WDW, & DOOR OPENING



REPUBLIC OF THE PHILIPPINES

PROVINCIAL ENGINEER'S OFFICE SAN AGUSTIN, DIGOS CITY, DAVAO DEL SUR

CONSTRUCTION AND IMPROVEMENT OF GREGORIO MATAS DISTRICT HOSPITAL (GMDH)

POBLACION, KIBLAWAN, DAVAO DEL SUR

PROJECT TITLE:

ESA JOY M. QAVALIDA COS EMPLOYEE

REPARED BY


ENGINEER G DIV HEAD AND PROGRAMM


REVIEWED B

RECOMMENDA PPROVAL LEONERL MARCHP SUARIO NCIAL ENGINEER **PROVI** 

MURARY YVONNE ROÑO CAGAS PROVINCIAL GOVERNOR

HEET NO .: S-2

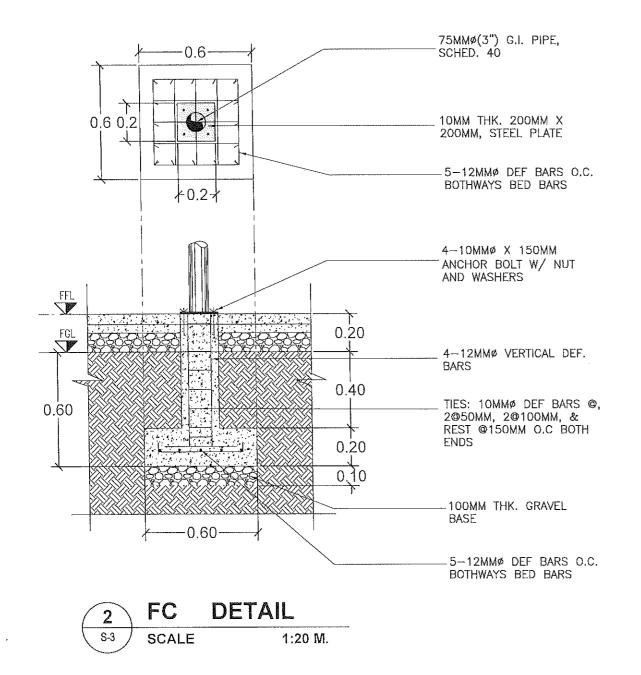

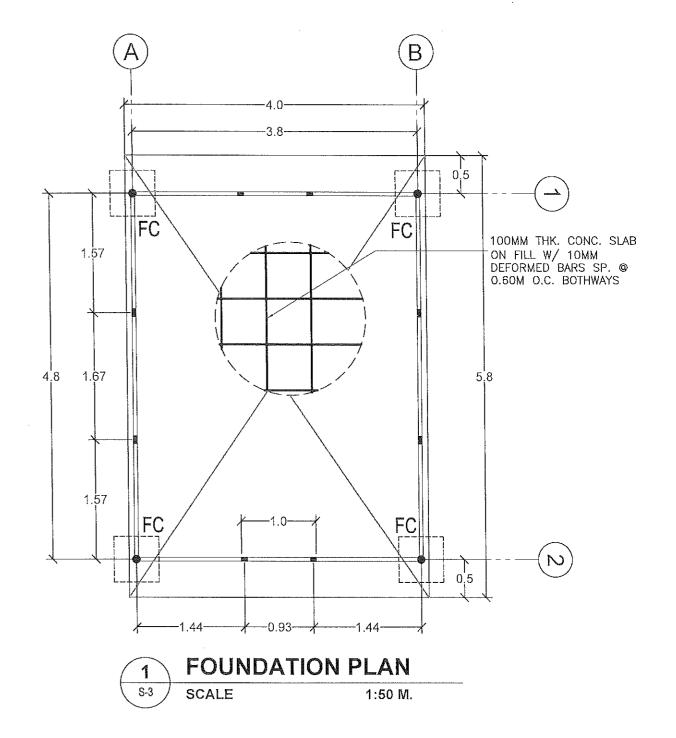



PROJECT TITLE: CONSTRUCTION AND IMPROVEMENT OF GREGORIO MATAS DISTRICT HOSPITAL (GMDH) POBLACION, KIBLAWAN, DAVAO DEL SUR

ESA JOY M. CAVALIDA COS EMPLOYEE

PREPARED BY:

HR. GONZALES ENGINEER -

REVIEWED BY

LEONERI MARCH P. SUARIO PROVINCIAL ENGINEER

G APPROVAL


RECOMMENDIN

ISSUAGUE YVONNE ROÑA CAGAS PROVINCIAL GOVERNOR


APPROVED 8Y:


S-3 10

SHEET NO.:

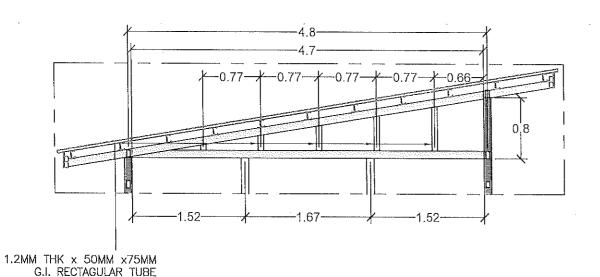





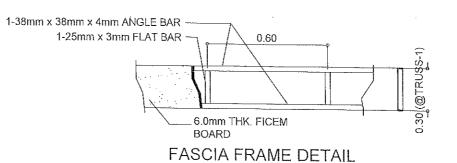

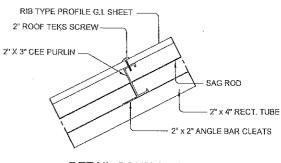

**DETAIL CONNECTION OF ROOFING TO PURLIN** 

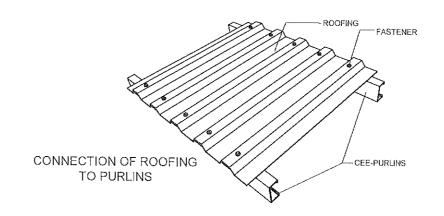

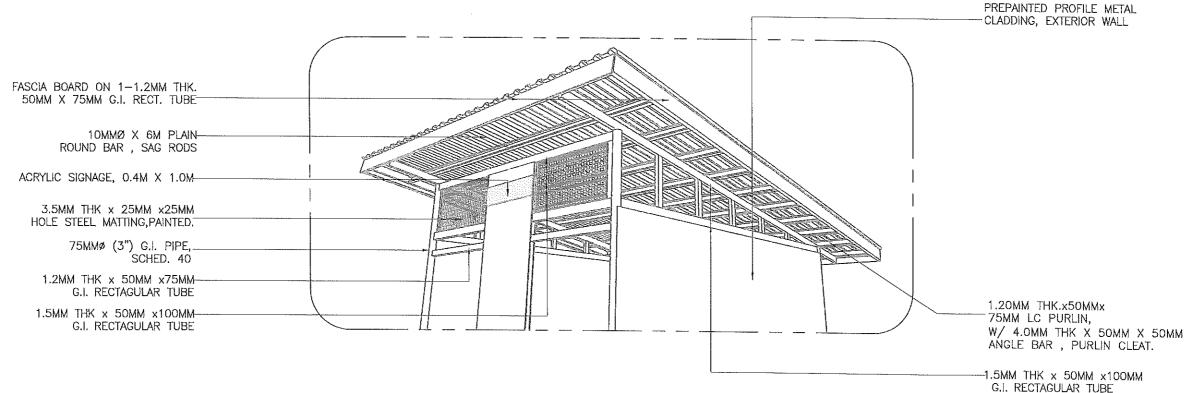

ALL MEASUREMENTS ARE TO BE VERIFIED ON SITE BY THE CONTRACTOR, ALL DISCREPANCIES ARE TO BE IMMEDIATELY REPORTED TO THE PROJECT ENGINEER

FINISHING ALL EXPOSED METAL SURFACES WITH PAINT

ISOMETRIC VIEW SCALE 1:50 M.

REPUBLIC OF THE PHILIPPINES PROVINCIAL ENGINEER'S OFFICE SAN AGUSTIN, DIGOS CITY, DAVAO DEL SUR

CONSTRUCTION AND IMPROVEMENT OF GREGORIO MATAS DISTRICT HOSPITAL (GMDH) POBLACION, KIBLAWAN, DAVAO DEL SUR

ESA JOY MU CAVALIDA COS EMPLOYEE

PREPARED BY:

HR. GONZALES ENGINEER -AND PROGRAM

LEQNERL MARCH P. SUARIO PROVINGIAL ENGINEER


RECOMMENDING PPROVAL:

YWW. AGAS

APPROVED BY

S-4 8

SHEET NO.:

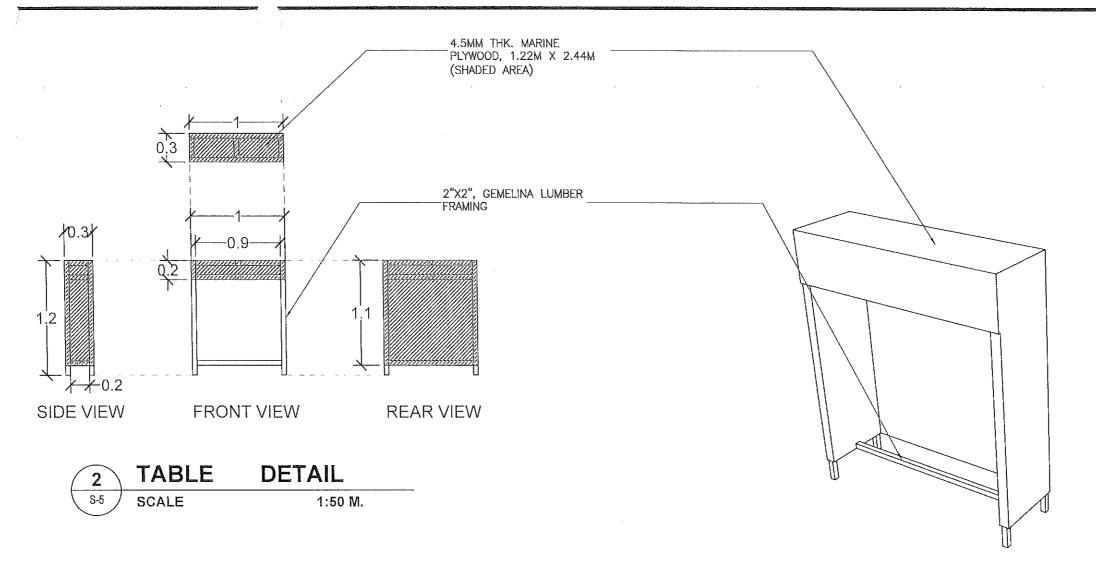

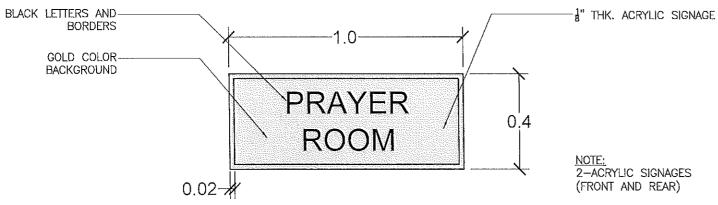


TABLE ISOMETRIC VIEW SCALE 1:50 M.

**ACRYLIC SIGNAGE DETAIL DNTS** 

REPUBLIC OF THE PHILIPPINES PROVINCIAL ENGINEER'S OFFICE SAN AGUSTIN, DIGOS CITY, DAVAO DEL SUR

CONSTRUCTION AND IMPROVEMENT OF GREGORIO MATAS DISTRICT HOSPITAL (GMDH)

POBLACION, KIBLAWAN, DAVAO DEL SUR

PREPARED BY: ESA JOY M. CAVALIDA COS EMPLOYEE

ENGINEER - IN MINING AND PROGRAMMI) IG DIV, HEAD

LEONERL WARCH P. SUARIO PROVINCIAL ENGINEER

PPROVAL:

RECOMMENDIN

APPROVED BY: SHEET NO.: IFFICAÇÃO YVONNE ROÑA CAGAS

PROVINCIAL GOVERNOR


S-5

ITEM NO.	ITEM DESCRIPTION:	UNIT	QUA NTITY
803(1)a	Structure Excavation (Common Soil)	cu.m.	1.00
804(7)	Gravel Fill	cu.m.	11.76 /
900(1)c	Structural Concrete, Class A, 3000 psi, 28 days	cu.m.	2.71
902(1)a1	Reinforcing Steel (Deformed) Grade 40	kilogram	109.66 <
903(2)	Formworks and Falseworks	lump sum	1.00 /
1003(2)f	Wall, Metal Cladding	sq. m.	31.01 /
1003(17)	Carpentry and Joinery Works	lump sum	1.00
1014(1)b2	Pre-painted Metal Sheets, above 0.427 mm, Rib Type, Long Span	sq. m.	36.11 /
1018(2)	Unglazed Tiles	sq. m.	24.00 /
1032(1)b	Painting Works, Wood	sq. m.	38.32 /
1032(1)c	Painting Works, Steel	sq. m.	57.80
1047(1)	Structural Steel	lump sum	1.00
SPL-1	Acrylic Signages	lump sum	1.00





## **SUMMARY OF QUANTITIES**

DNTS

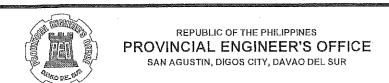

OJECT TITLE:
CONSTRUCTION AND IMPROVEMENT OF REGORIO MATAS DISTRICT HOSPITAL (GMDH)
CATION:
POBLACION, KIBLAWAN, DAVAO DEL SUR

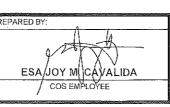

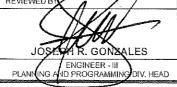

RECOMMENDING APPROVAL: LEONERL MARCH P. SUARIO PROVINCIAL ENGINEER

YVONNE ROÑA CAGAS
PROVINCIAL GOVERNOR


APPROVED BY:


O-0


10 10


SHEET NO.:

6. DRAINAGE/CANAL WITH COVER

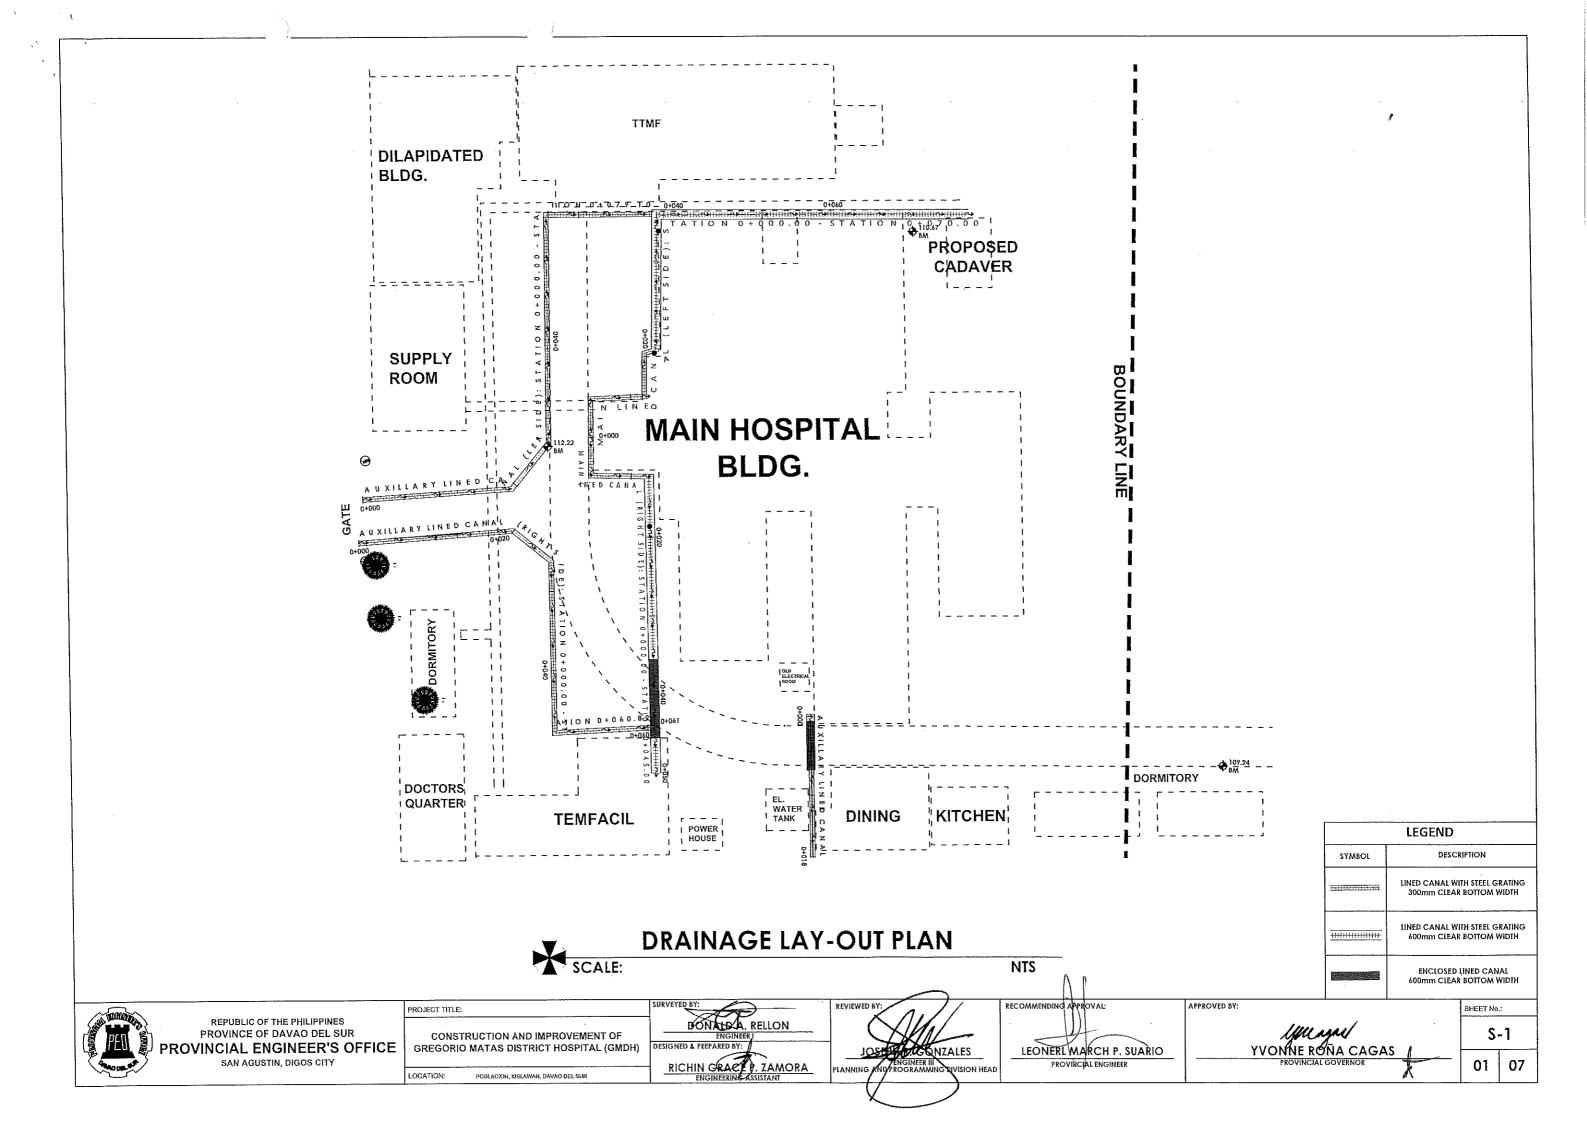

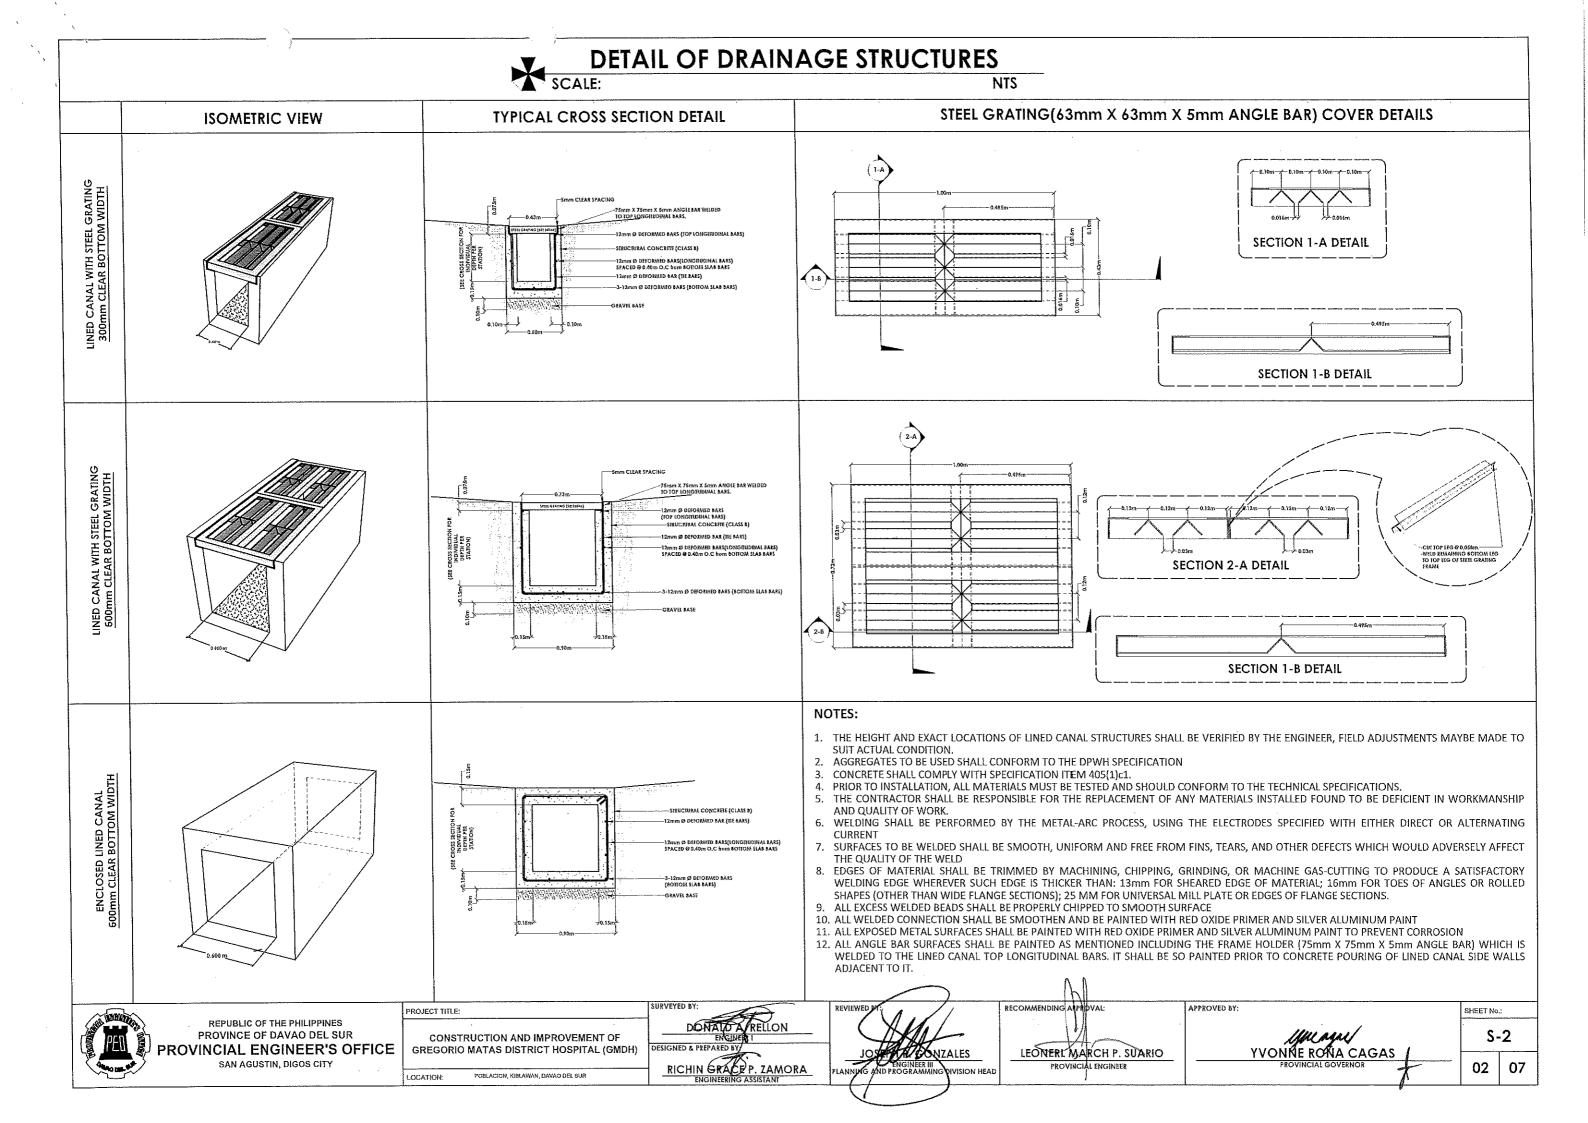


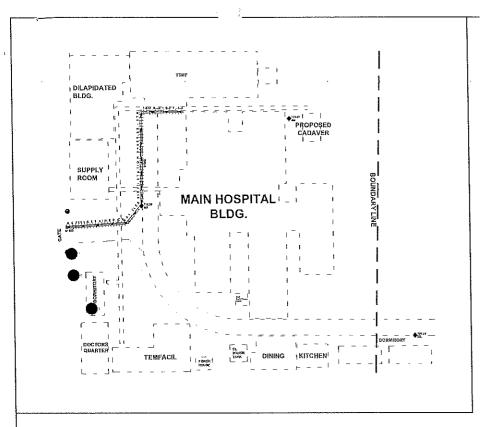

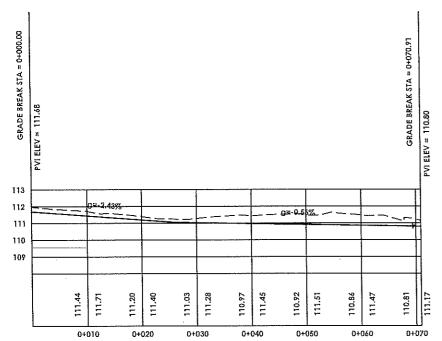



I G	DRAI	NAGE SCHEDULE
STATION	LENGTH (m)	REMARKS
0+000.00 - 0+070.91	70.91	LINED CANAL WITH STEEL GRATING 300mm CLEAR BOTTOM WIDTH

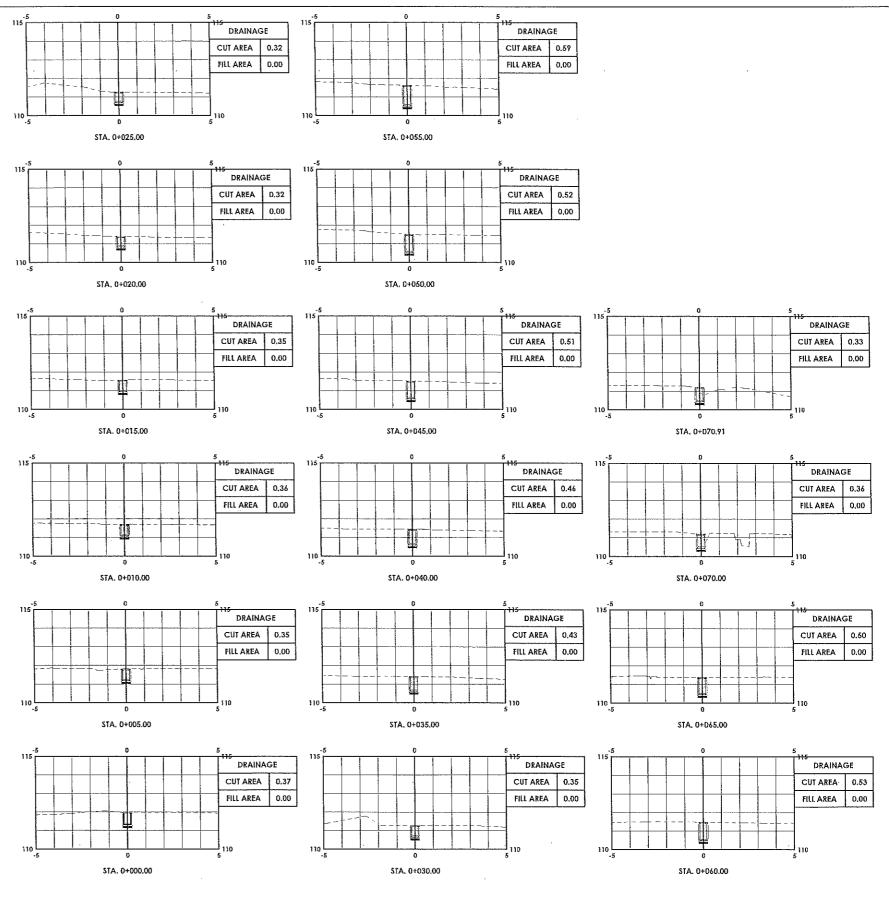

#### **DRAINAGE CROSS SECTION**

AUXILLARY LINED CANAL (LEFT SIDE)

TEONER MARCH P. SUARIO

1:200

APPROVED BY:

SHEET No.: **S-3** 

> 03 07

REPUBLIC OF THE PHILIPPINES PROVINCE OF DAVAO DEL SUR ROVINCIAL ENGINEER'S OFFICE SAN AGUSTIN, DIGOS CITY

CONSTRUCTION AND IMPROVEMENT OF GREGORIO MATAS DISTRICT HOSPITAL (GMDH)

POBLACION, KIBLAWAN, DAVAO DEL SUR


PROJECT TITLE:


DONALD A RELLON

RICHIN GRACEP, ZAMORA

LOSE A R. CONZALES

PROVINCIAL ENGINEER

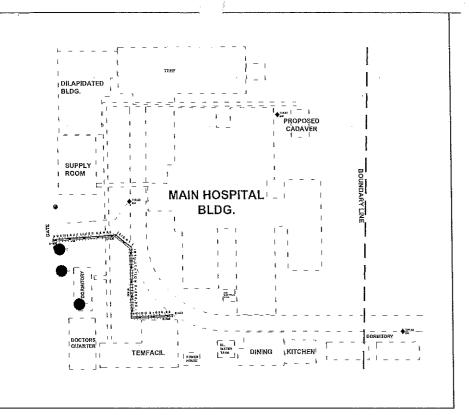

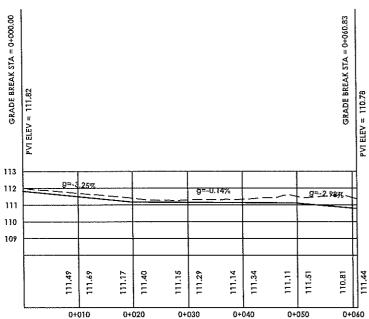




ļ	DRAIN	AGE SCHEDULE
STATION	LENGTH (m)	REMARKS
0+000,00 - 0+060,82	60.82	LINED CANAL WITH STEEL GRATING 300mm CLEAR BOTTOM WIDTH

REPUBLIC OF THE PHILIPPINES PROVINCE OF DAVAO DEL SUR

SAN AGUSTIN, DIGOS CITY

ROVINCIAL ENGINEER'S OFFICE

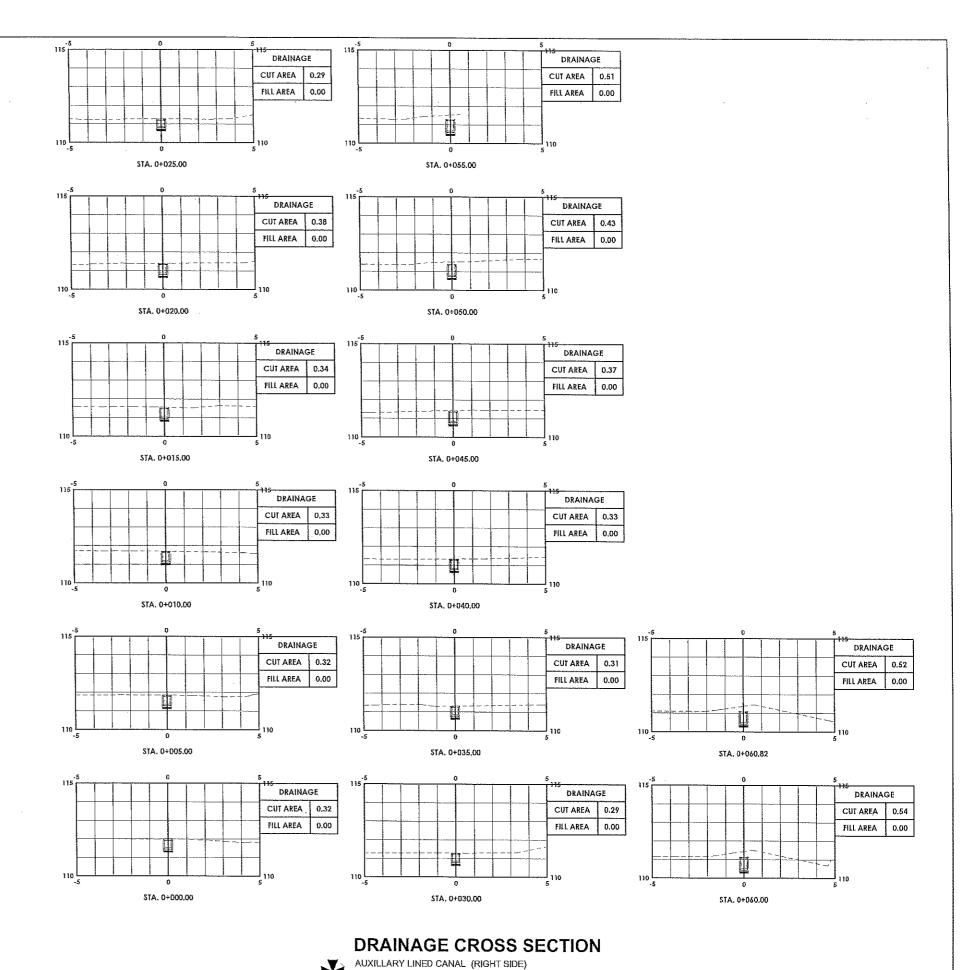

PROJECT TITLE:

CONSTRUCTION AND IMPROVEMENT OF

GREGORIO MATAS DISTRICT HOSPITAL (GMDH)

LEONERL MARCH P. SUARIO

APPROVED BY: YVONNÉ RONA CAGAS
PROVINCIAL GOVERNOR

SHEET No.: S-4


04 07


POBLACION, KIBLAWAN, DAVAO DEL SUR LOCATION:


RICHIN GRAPP, ZAMORA ENGINEERING ASSISTANT

PROVINCIAL ENGINEER


1:2200

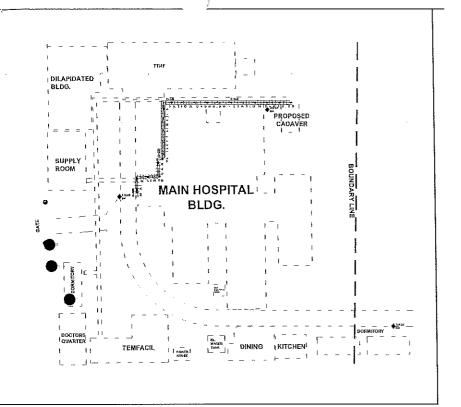

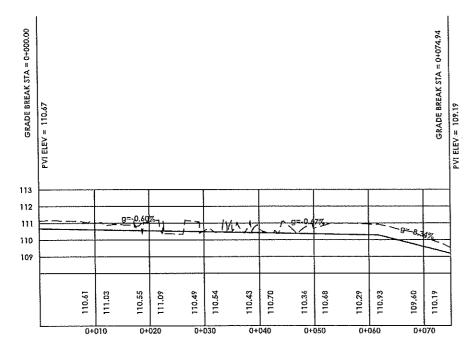

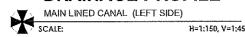

	DRA	DRAINAGE SCHEDULE		
STATION	LENGTH (m)	REMARKS		
0+000.00 - 0+020.00	20,00	LINED CANAL WITH STEEL GRATING 300mm CLEAR BOTTOM WIDTH		
0+020.00 - 0+070.00	50,00	LINED CANAL WITH STEEL GRATING 600mm CLEAR BOTTOM WIDTH		

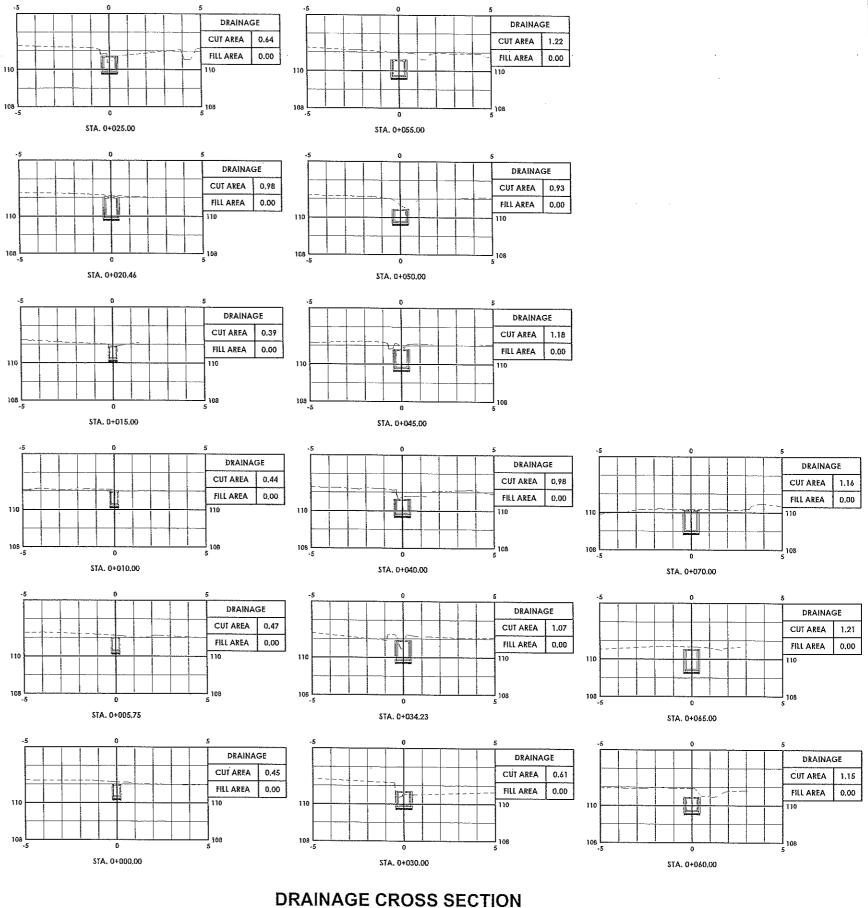

MAIN LINED CANAL (LEFT SIDE) 1:200



REPUBLIC OF THE PHILIPPINES PROVINCE OF DAVAO DEL SUR ROVINCIAL ENGINEER'S OFFICE SAN AGUSTIN, DIGOS CITY

CONSTRUCTION AND IMPROVEMENT OF GREGORIO MATAS DISTRICT HOSPITAL (GMDH)

POBLACION, KIBLAWAN, DAYAO DEL SUR

PROJECT TITLE:

RICHIN GRAGEP, ZAMORA

CSEMPLES GONZALES


RECOMMENDING APPROVAL: LEONERL MARCH P. SUARIO


SHUSAN YVONNE RONA CAGAS

APPROVED BY:

SHEET No.: S-5


05 07

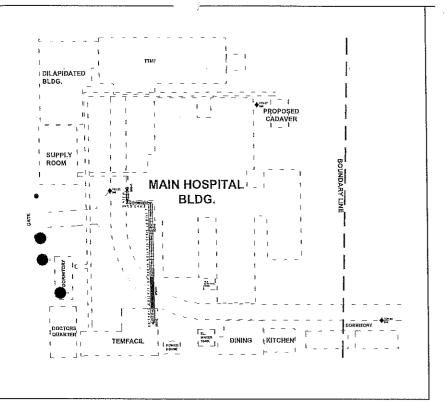

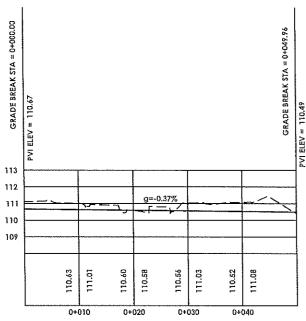

#### **DRAINAGE PROFILE** MAIN LINED CANAL (RIGHT SIDE) SCALE: H H=1:150, V=1:450

	DRA	INAGE SCHEDULE
STATION	LENGTH (m)	REMARKS
0+000.00 - 0+015.00	15.00	LINED CANAL WITH STEEL GRATING 300mm CLEAR BOTTOM WIDTH
0+015.00 - 0+035.00	20.00	LINED CANAL WITH STEEL GRATING 600mm CLEAR BOTTOM WIDTH
0+035.00 - 0+045.00	10.00	ENCLOSED LINED CANAL 600mm CLEAR BOTTOM WIDTH
0+045.00 - 0+049.96	4.96	LINED CANAL WITH STEEL GRATING 600mm CLEAR BOTTOM WIDTH

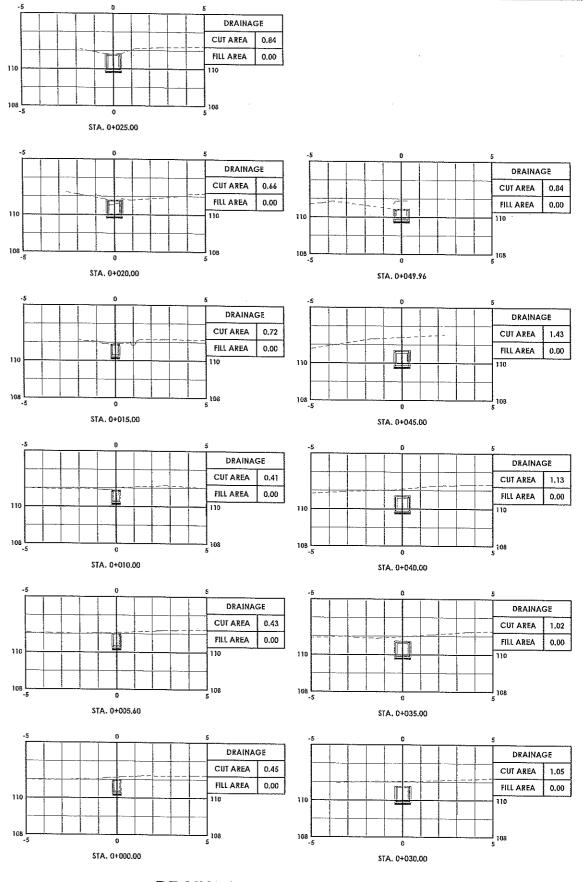

#### **DRAINAGE CROSS SECTION**

MAIN LINED CANAL (RIGHT SIDE)
SCALE:

APPROVED BY:

SHEET No.: 5-6

PROJECT TITLE: REPUBLIC OF THE PHILIPPINES PROVINCE OF DAVAO DEL SUR ROVINCIAL ENGINEER'S OFFICE

CONSTRUCTION AND IMPROVEMENT OF GREGORIO MATAS DISTRICT HOSPITAL (GMDH)

POBLACION, KIBLAWAN, DAVAO DEL SUR

LOCATION:

RICHINGRACE P. ZAMORA
ENGINEERING ASSISTANT


FERR. SONZALES


LEONERLMARCH P. SUARIO

RECOMMENDING APPROVAL

06


07

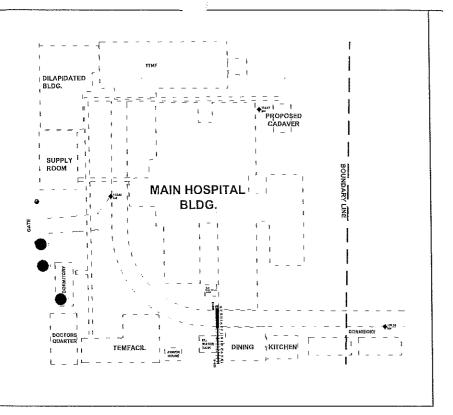

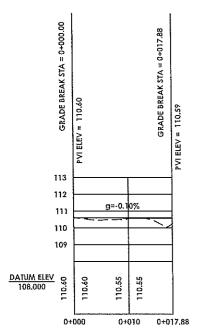



DRAINAGE SCHEDULE		
STATION	LENGTH (m)	REMARKS
0+000.00 - 0+1.00	1.00	LINED CANAL WITH STEEL GRATING 600mm CLEAR BOTTOM WIDTH
0+01.00 - 0+07.00	6.00	ENCLOSED LINED CANAL 600mm CLEAR BOTTOM WIDTH
0+07.00 - 0+017.85	10.85	LINED CANAL WITH STEEL GRATING 300mm CLEAR BOTTOM WIDTH

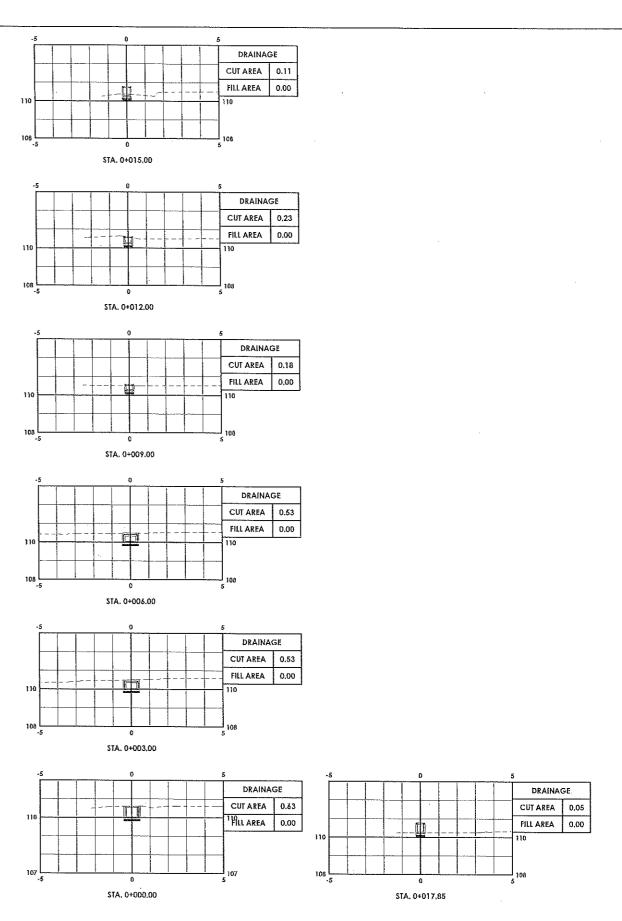

#### **DRAINAGE CROSS SECTION**



CONSTRUCTION AND IMPROVEMENT OF GREGORIO MATAS DISTRICT HOSPITAL (GMDH)

POBLACION, KIBLAWAN, DAVAO DEL SUR

PROJECT TITLE:

LOCATION:

RICHNISTAGE P. ZAMORA ENGINEERING ASSISTANT

RECOMMENDING APROVAL

LEONERY MARCH P. SUARIO

SHLAGAL/ YVONNE ROMA CAGAS


SHEET No.: **S-7** 

07 07

DIVISION HEAD

APPROVED BY:

7. LANDSCAPING

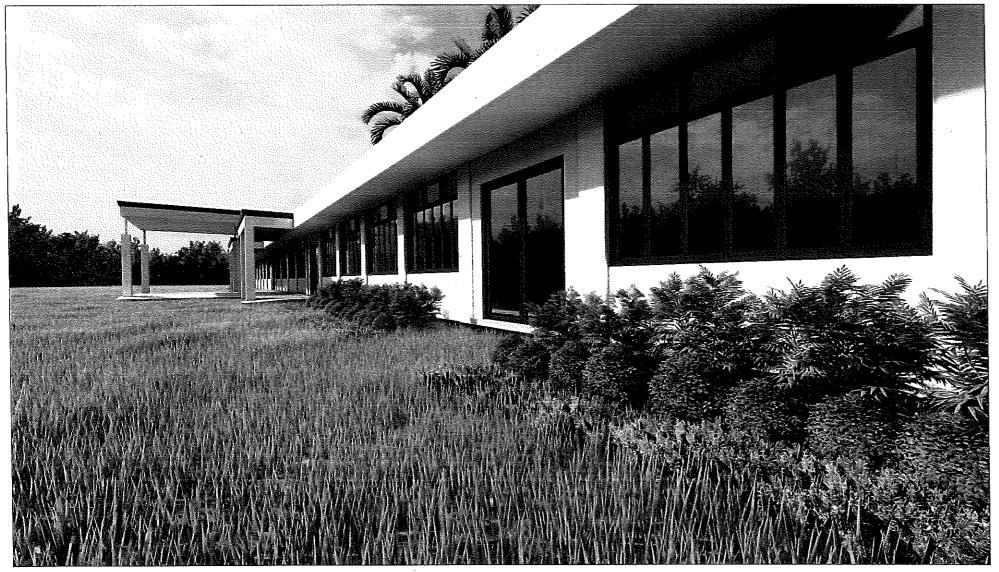

PERSPECTIVE NOT TO SCALE DRAWN

TABLE OF CONTENTS OFFICE OF THE BUILDING OFFICIAL ARCHITECTURAL DISTRICT/CITY/MUNICIPALITY PERSPECTIVE SITE DEVELOPMENT PLAN LANDSCAPE PLAN,
LANDSCAPE LEGEND,
LANDSCAPE DETAILS,
TYPICAL SUBSTRATE FOR
LANDSCAPE PLANTS LAND USE AND ZONING OTHER LINE AND GRADE SUMMARY OF QUANTITIES ARCHITECTURAL STRUCTURAL SANITARY ELECTRICAL MECHANICAL

REPUBLIC OF THE PHILIPPINES
DEPARTMENT OF PUBLIC WORKS AND HIGHWAYS



REPUBLIC OF THE PHILIPPINES PROVINCIAL ENGINEER'S OFFICE SAN AGUSTIN, DIGOS CITY, DAVAO DEL SUR

CONSTRUCTION AND IMPROVEMENT OF GREGORIO MATAS DISTRICT HOSPITAL (GMDH)


POBLACION, KIBLAWAN ,DAVAO DEL SUR

ADNAN SHÂMIR L, PIÑOL

REPARED BY:


ENGINEER - III G AND PROGRAMMIN

LEONER MARCH P. SUARIO PROVINCIAL ENGINEER

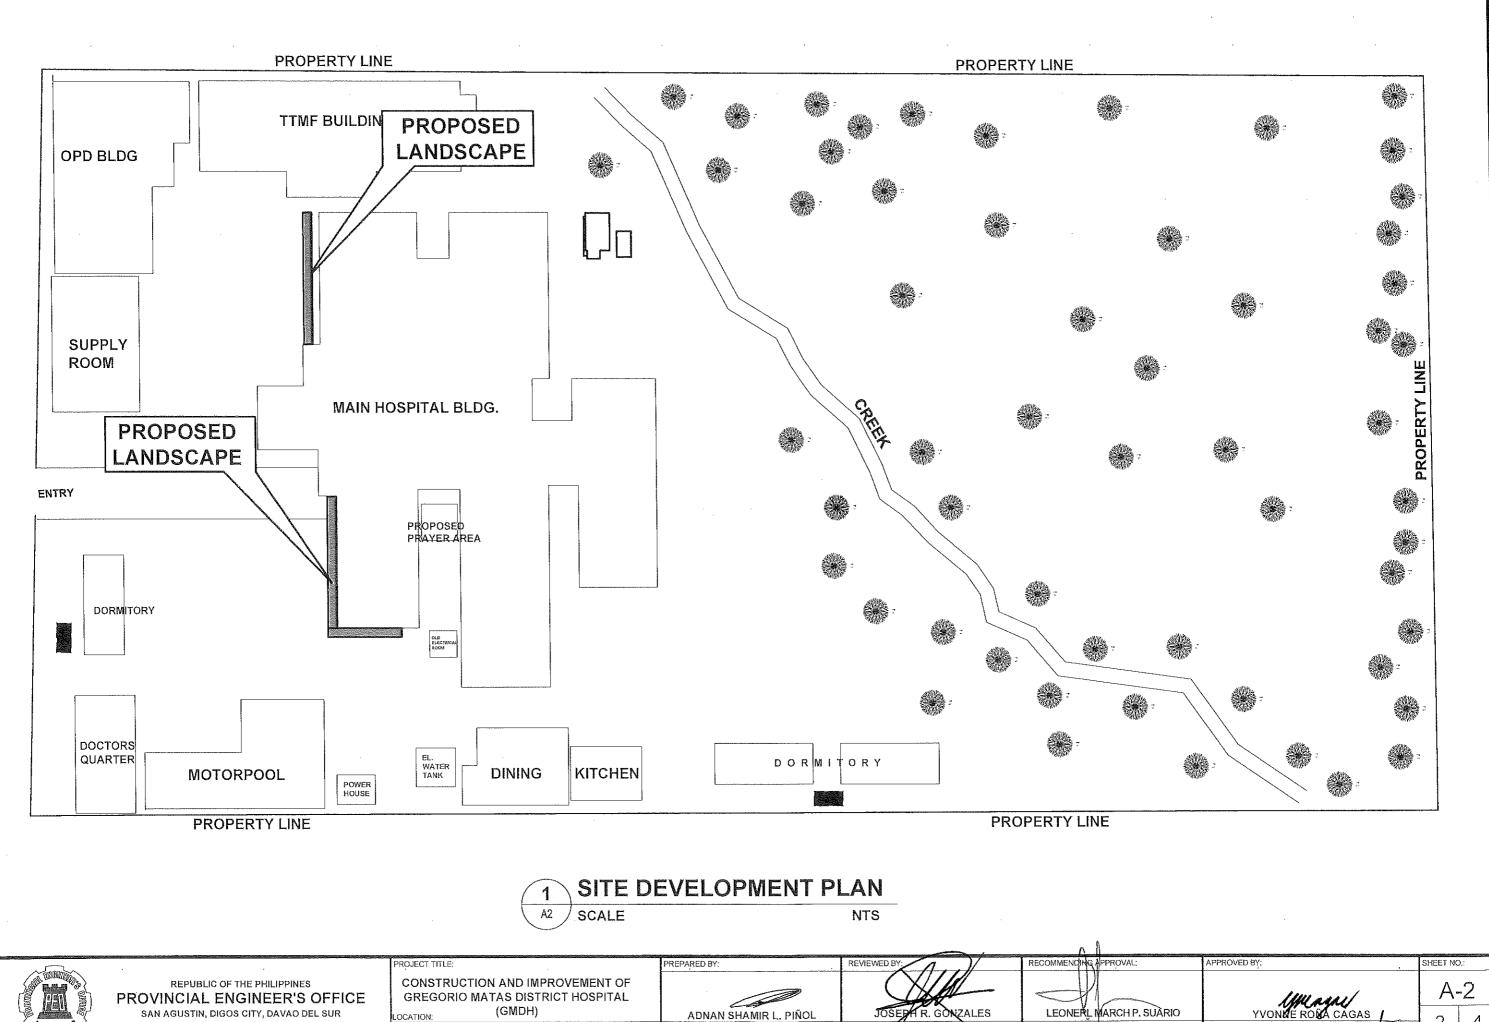

POBLACION, KIBLAWAN ,DAVAO DEL SUR

ARCHITECT II

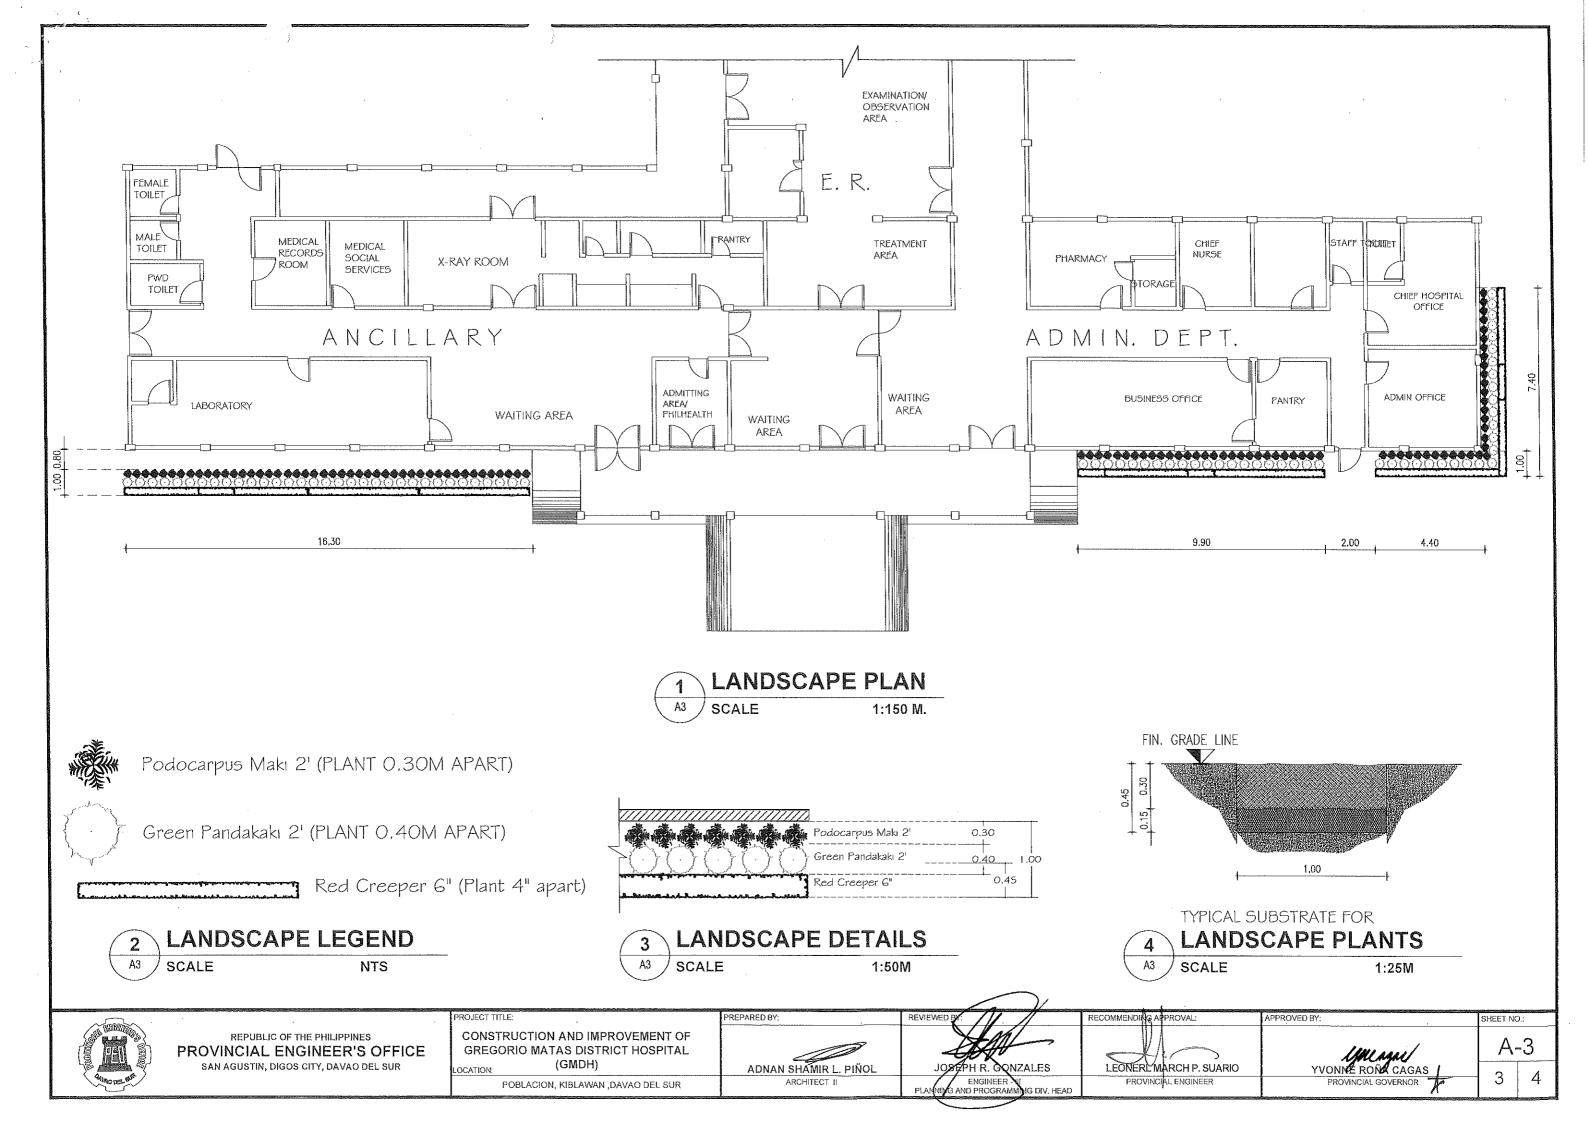

TTEM NO.	DESCRIPTION	%	QTY.	UNIT
PART C	EARTHWORK			
803(1)a	Structure Excavation	1.05	17.10	cu.m.
	TOTAL OF PART C			
PARTE	PART E FINISHINGS AND OTHER CIVIL WORKS			
SPL	Landscaping	98.95	38.00	sqm
	TOTAL OF PART E 9			

**SUMMARY OF QUANTITIES** SCALE



CONSTRUCTION AND IMPROVEMENT OF GREGORIO MATAS DISTRICT HOSPITAL (GMDH)

POBLACION, KIBLAWAN , DAVAO DEL SUR

ADNAN SHAMIR L. PIÑOL


PREPARED BY:


APPROVED BY:


YVONNE ROM CAGAS
PROVINCIAL GOVERNOR

LEONERL MARCH P. SUARIO

8. CONCRETE PATHWAY

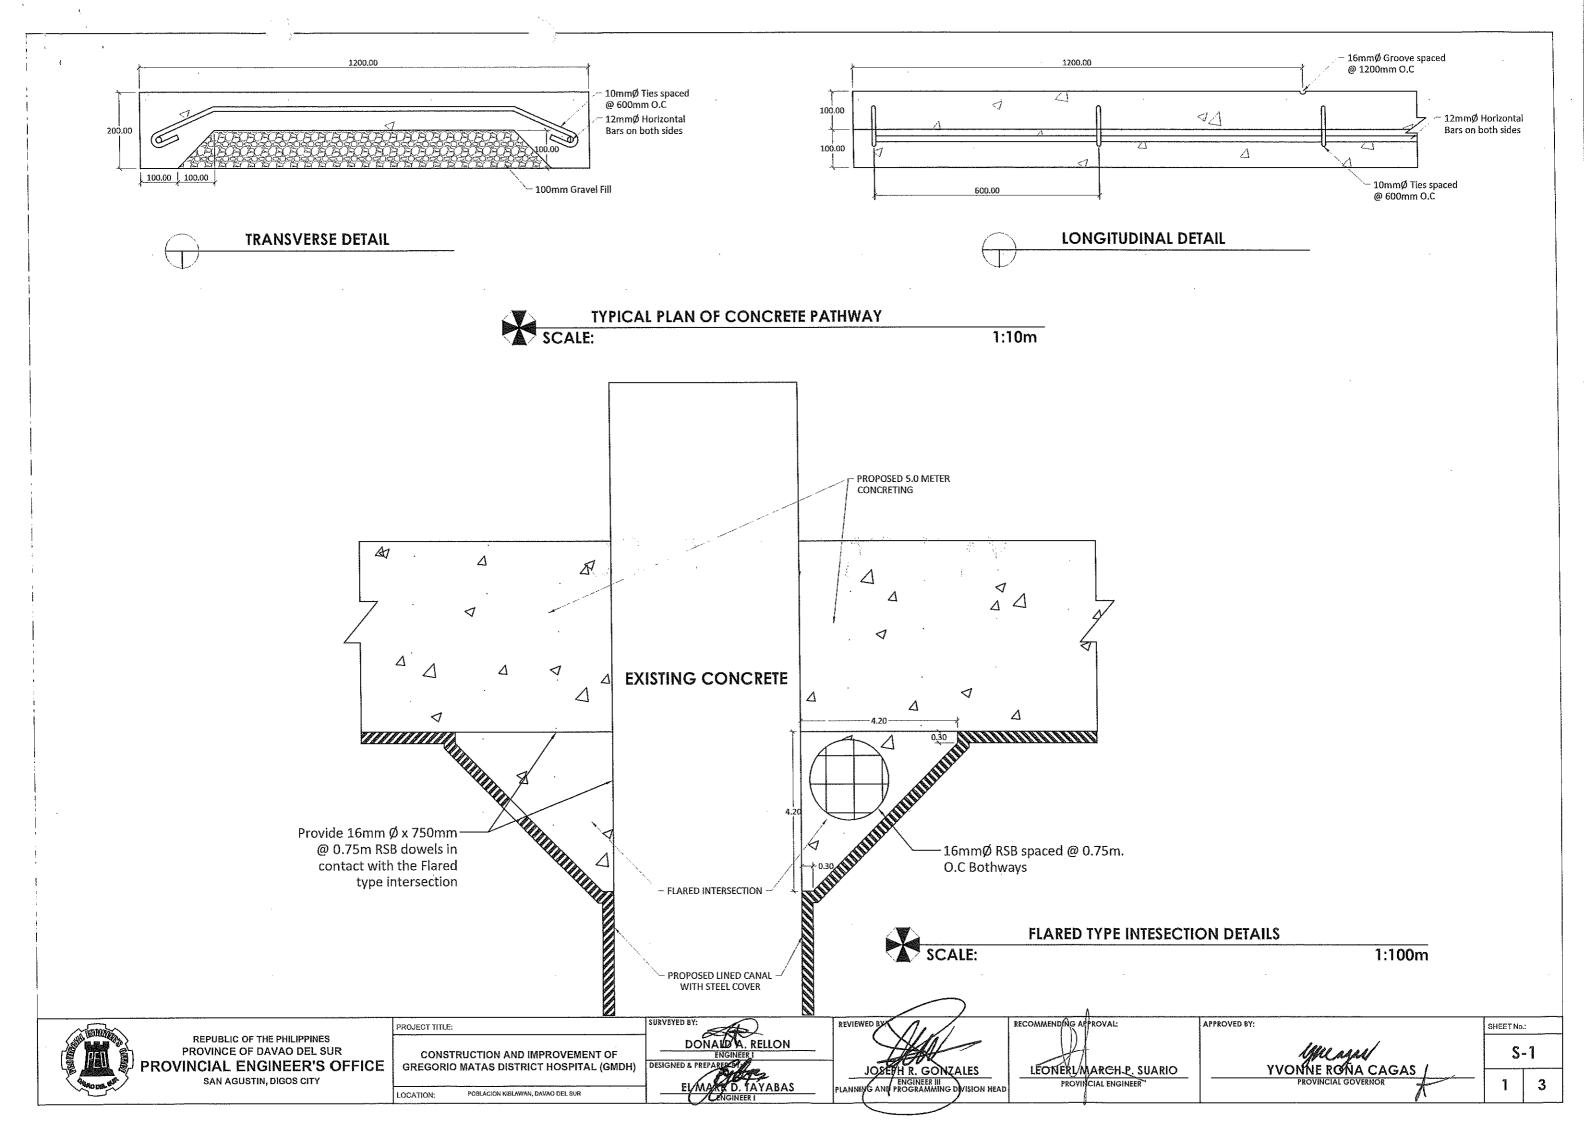


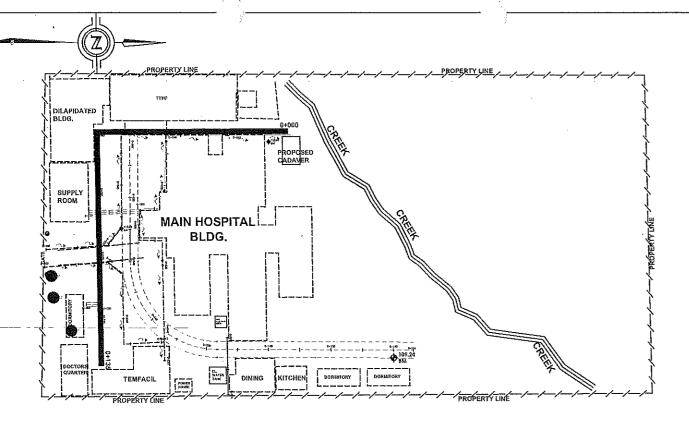

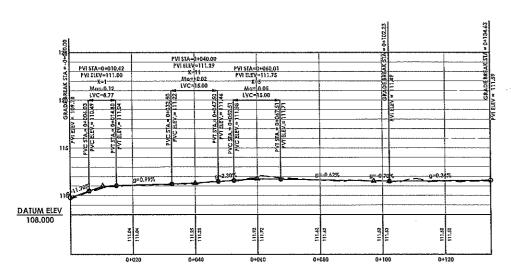

\*NOTE: **VERTICAL EXAGERATION= 3.0** 



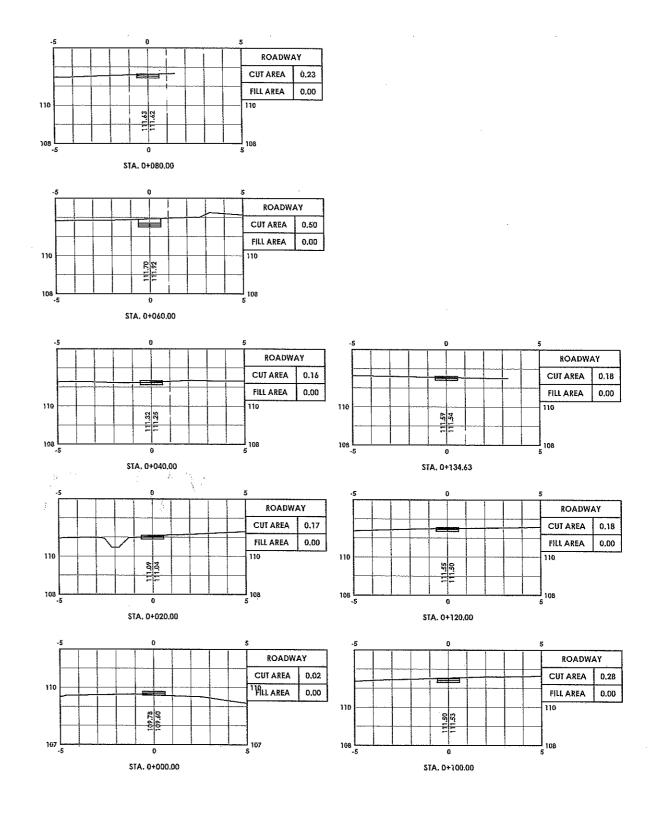

#### PATHWAY CROSS SECTIONS 1 SCALE: 1:200m



PROJECT TITLE:

CONSTRUCTION AND IMPROVEMENT OF GREGORIO MATAS DISTRICT HOSPITAL (GMDH)

POBLACION KIBLAWAN, DAVAG DEL SUR

ENGINEER III

RECOMMENDING APPROVAL

LEONERL MARCH P. SUARIO

PROVINCIAL ENGINEER


APPROVED BY:


Ifficagae YVONNE RONA CAGAS


**S-2** 


SHEET No.:


2

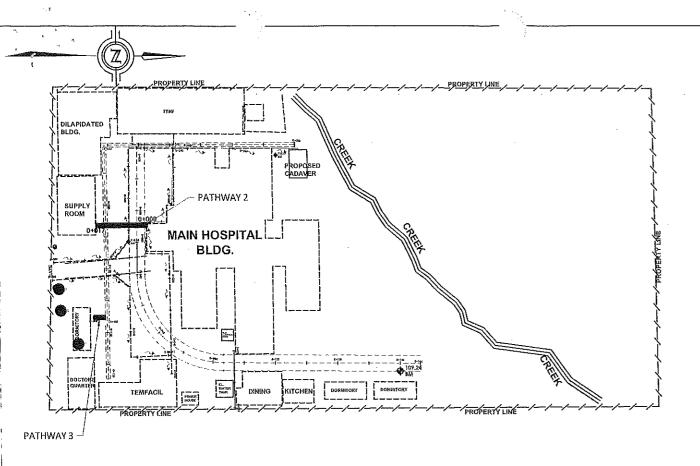


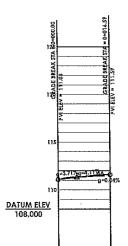

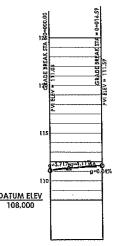


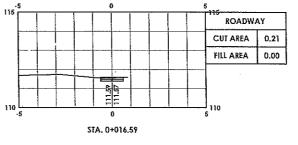


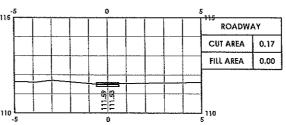


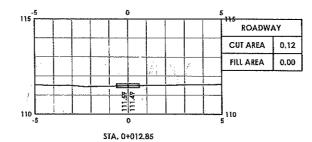

STA. 0+014.05

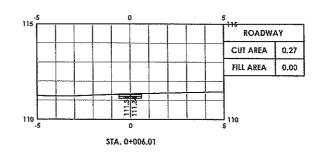

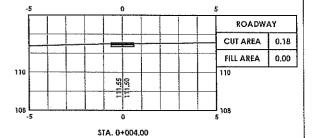

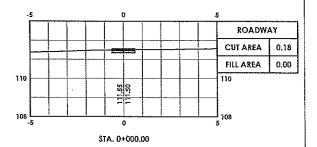

PATHWAY PLAN AND PROFILE 2
SCALE: 1:1200m





REPUBLIC OF THE PHILIPPINES PROVINCE OF DAVAO DEL SUR ROVINCIAL ENGINEER'S OFFICE SAN AGUSTIN, DIGOS CITY

PROJECT TITLE:

CONSTRUCTION AND IMPROVEMENT OF

**GREGORIO MATAS DISTRICT HOSPITAL (GMDH)** 

POBLACION KIBLAWAN, DAVAG DEL SUR

RECOMMENDING ATPROVAL

LEONERL MARCH P. SUARIO PROVINCIAL ENGINEER

APPROVED BY:

SHEET No.; **S-3** 

# SECTION VIII.

[See attached file.]

I

## Republic of the Philippines PROVINCE OF DAVAO DEL SUR PROVINCIAL ENGINEER'S OFFICE SUN AGUSTIN, D'IGOS-CIEY

## BILL OF QUANTITIES

CONSTRUCTION AND IMPROVEMENT OF GREGORIO MATAS DISTRICT HOSPITAL

Location of the Contract Project Duration POBLACION, KIBLAWAN, DAVAO DEL SUR
180 Calendar Days

Contract Name

### SUMMARY OF BID PRICES (All Parts of Bill of Quantities)

- 1. Part No. Enter the "Part No." for each section of the Bill of Quantities (BOQ) where unit prices are entered.
  2. Part Description Enter the "Part Description" corresponding to the "Part No."
  3. Total Amount Enter the "total amount" in Pesos for all pages having the same "Part Description".
  4. Adopting Green Procurement Policy by SBAC Resolution No. 140 series of 2019.

	Coors (stocks effect)	1010(2/0
	Head Transoms and Mullions)	1010(1)
D		TUU8(I)a
		1000(1)
	Mode	1003(2):
		1003/214
	ment Board on Metal Frame Ceiling	1003(1)61
P	This is a second of the second	1002(27)
0	777777777	1002(24)
P	Plumbing Fixtures .	1002(4)
P	Septic Vault	1001(11)
P	Formworks and Falseworks	903 (2)
P	Reinforcing Steel (Deformed) Grade 40	902 (1)a1
יסר	Structural Concrete ,Class A, 3000 psi, 28 days	900(1)c
P		804(7)
P	Excavation, (Common Soil)	803(1)a
P	Clearing and Grubbing	800(2)
Total Amount	Part Description	Part No.
- Applications - Appl	CADAVER HOLDING AREA	4. CADAVER I
P	Solar LED Street Light (Integrated Street Light)	624(8)
P	Painting Works, Steel	1032(1)c
Р	Painting Works, Masonry/Concrete	1032(1)a
q	Structural Steel	1047(1)
P	Cement Plaster Finish	1027 (1)
P	CHB Non Load Bearing ( Including Reinforcing Steel), 100mm	1046(2)a1
P	Formworks and Falseworks	903 (2)
P	Reinforcing Steel (Deformed) Grade 40	902 (1)a1
P	Structural Concrete ,Class A, 3000 psi, 28 days	900 (1)c
P	Gravel Fill	804 (4)
ъ	Structure Excavation (Common Soil)	803 (1)a
קי	Clearing and Grubbing	800 (2)
Total Amount	Part Description	Part No.
	3. PERIMETER FENCE WITH SOLAR LIGHTS	3. PERIMETER
ק	Portland Cement Concrete Pavement (Unreinforced), 200mm thk.	311(1)b1
Р	Aggregate Subbase Course	200(1)
P	Subgrade Preparation (Common Material)	105(1)a
P	Embankment from roadway excavation (Common Soil)	104(1)a
P	Surplus Common Excavation	102(2)
P	Clearing & Grubbing (with Stripping)	100(1)
Total Amount	Part Description	Part No.
	ROAD	2. CONCRETE ROAD
P	Septic Vault	1001(11)
P	Formworks and Falseworks	903(2)
Q.	Structure Excavation, (Common Soil)	803(1)a
P	Mobilization / Demobilization	B.9
P	Occupational Safety and Health	8.7
P	Project Billboard/Signboard	В.5
P	Permits and Clearances	В.З
Total Amount	Part Description	Part No.
With the second	1. SEPTIC TANK FOR DORMITORIES (3 DORMS)	1. SEPTIC TAI
		Contract ID:

	סי	Reinforcing Steel (Deformed ), Grade 40	902(1)a
	P	Structural Concrete, Class A, 14 Days	900(1)b1
	q	Gravel fill	804(4)
	P	Surplus Common Excavation	802(2)
	סי	Clearing & Grubbing	800(2)
Total Amount		Part Description	Part No.
		PATHWAY	8. CONCRETE PATHWAY
	ס	Landscaping	SPL
	ď	Structure Excavation	803(1)a
Total Amount		Part Description	Part No.
		ING	7. LANDSCAPING
	P	Metal Frame and Grating	503(1)
11777777777	סי	Structural Concrete Class "B" (7 days)	405(1)c1
11111	ď	Reinforcing Steel Bar, Grade 40 (Minor Structures)	404(1)a
100000000000000000000000000000000000000	P	Structure Excavation	103(1)
Total Amount		Part Description	Part No.
THE CONTRACT OF THE CONTRACT O		6. DRAINAGE/CANAL WITH COVER	6. DRAINAGE
	٩	Acrylic Signages	SPL-1
	70	Structural Steel	1047(1)
	Р	Painting Works, Steel	1032(1)c
	P	Painting Works, Wood	1032(1)b
	P	Unglazed Tiles	1018(2)
	P		1014(1)b2
	ס	Carpentry and Joinery Works	1003(17)
	ס	Wall, Metal Cladding	1003(2)f
	70	Formworks and Falseworks	903(2)
	סי	Reinforcing Steel (Deformed), Grade 40	902(1)a1
A A A A A A A A A A A A A A A A A A A	P	Structural Concrete, Class A, 3000 psi, 28 days	900(1)c
TANK TANK TANK TANK TANK TANK TANK TANK	P	Gravel Fill	804(7)
	סר	Structure Excavation (Common Soil)	803(1)a
Total Amount		Part Description	Part No.
		ООМ	5. PRAYER ROOM
- Annual	q	Lighting Fixtures	1103 (1)
The state of the s	ď	Panelboard with Main & Branch Breakers	1102 (1)
**************************************	٥		1101(33)
- The state of the	ס		1100 (10)
**************************************	יטי		1047 (1)
hydrican harmonic and harmonic	P	CHB Non-Load Bearing(Including reinforcing Steel),100mm	1046(2)a1
	ρ	Reflective Insulation	1038(1)
17000000000000000000000000000000000000	P	L.,	1032(1)c
	ď		1032(1)b
	P	Painting Works, Masonry/Concrete	1032(1)a
The state of the s	סי	Cement Plaster Finish	1027(1)
The state of the s	70		1018 (5)
AND THE PARTY OF T	P	Pre-painted Metal Sheets, above 0.427 mm, Rib Type, Long Span	1014(1)b2
	P	1 Fabricated Metal Roofing Accessory (Gauge 26 (0.551 mm), Ridge Roll)	1013 (2) a1

(T) (+)T	בים מכנמו מי כנסמו		
1100 (10)	Conduits, Boxes & Fittings (Conduit Works/Conduit Rough-In)	P	***************************************
1102 (1)	Panelboard with Main & Branch Breakers	ত ব	
1103 (1)	Lighting Fixtures	P	
5. PRAYER ROOM	MOOM		
Part No.	Part Description		Total Amount
803(1)a	Structure Excavation (Common Soil)	P	
804(7)	Gravel Fill	P	
900(1)c	Structural Concrete, Class A, 3000 psi, 28 days	P	
902(1)a1	Reinforcing Steel (Deformed), Grade 40	q	
903(2)	Formworks and Falseworks	ъ	T-1-A-Million control
1003(2)f	Wall, Metal Cladding	ס	
1003(17)	Carpentry and Joinery Works	ס	
1014(1)b2	Pre-painted Metal Sheets, above 0.427 mm, Rib Type, Long Span	ď	
1018(2)	Unglazed Tiles	P	
1032(1)b	Painting Works, Wood	p	Ministrative Control of the Control
1032(1)c	Painting Works, Steel	σ	
1047(1)	Structural Steel	ъ	
SPL-1	Acrylic Signages	סי	
6. DRAINAGE	6. DRAINAGE/CANAL WITH COVER		
Part No.	Part Description	,	Total Amount
103(1)	Brinfarsing Strol Bay Condo AD (Minor Structures)	σ \ τ	The second secon
405(1)c1	Structural Concrete Class "B" (7 days)	-0	144,000,000
503(1)	Metal Frame and Grating	P	and a second of the second of
7. LANDSCAPING	ING		
Part No.	Part Description	,	Total Amount
SPL	Landscaping	ο.	
8. CONCRETE PATHWAY	PATHWAY		
Part No.	Part Description		Total Amount
800(2)	Clearing & Grubbing	יסי	
802(2)	Surplus Common Excavation	70	
804(4)	Gravel fill	יסי	
900(1)b1	Structural Concrete, Class A, 14 Days	P	
902(1)a	Reinforcing Steel (Deformed ), Grade 40	-0	1440-ann
	**************************************	,	
	iota ei Al Amounts	1	
Total of All A	Total of All Amounts in Words: PESOS		
	and	33	centavos
Name :	In capacity of		
Signed :	Date		

## Republic of the Philippines PROVINCE OF DAVAO DEL SUR PROVINCIAL ENGINEER'S OFFICE Surv Aquatin, DigorCity

Location of the Contract : POBLACION, KIBLAWAN, DAVAO DEL SUR

### BILL OF QUANTITIES

1. SEPTIC TANK FOR DORMITORIES (3 DORMS)
Part No.

Project Duration

: 180 Calendar Days

Pav				Init Price	A-main+
Item No.	Description	Unit	Quantity	(Pesos)	(Pesos)
jt	2	3	4	5	6
88 E3	Permits and Clearances	V <sub>P</sub>	1.00	in words:	In words:
			R		
				In figures:	In figures:
B.5	Project Billboard/Signboard	each	1.00	In words:	In words:
6		ħ.			
				T PANTAL TOTAL TOT	
				In figures:	In figures:
B.7	Occupational Safety and Health	I.s.	1.00	In words:	In words:
		K	Ŋ		Q112
				In figures:	in figures:
8.9	Mobilization / Demobilization	īs.	1.00	In words:	In words:
\	``	ř.	ŧ.		
				In figures:	In figures:
				The state of the s	
803(1)a S	Structure Excavation, (Common Soil)	cu.m.	39.90	In words:	In words:
٢,		e.			
			····	In figures:	In figures:
Submitted by:	γ;				
				Date .	

Position	Name of the Representative of the Bidder
	Date :

Name of Bidder

Contract Name Location of the C Project Duration	ontract :	TION AND I, KIBLAW	IMPROVEN	: CONSTRUCTION AND IMPROVEMENT OF GREGORIO MATAS DISTRICT HOSPITAL POBLACION, KIBLAWAN, DAVAO DEL SUR 180 Calendar Days BILL OF QUANTITIES	ITAL
1. SEPTIC: Part No.	1. SEPTIC TANK FOR DORMITORIES (3 DORMS) Part No.				
Pay Item No.	Description	Unit	Quantity	Unit Price (Pesos)	Amount (Pesos)
1	2	3	4	5	6
903(2)	Formworks and Falseworks	sq.m.	21.00	In words:	In words:
N. Carlotte			1		, And the state of
				in figures:	In figures:
					Pitty, and the state of the sta
1001(11)	1001(11) Septic Vault	K <u>K</u>	1.00	In words:	In words:
				In figures:	In figures:
				The state of the s	
Submitted by:	y;			Control of the Contro	
Name of the	Name of the Representative of the Bidder			Date :	
Position					

Name of Bidder

Contract Name : CONSTRUCTION AND IMPROVEMENT OF GREGORIO MATAS DISTRICT HOSPITAL
Location of the Contract : POBLACION, KIBLAWAN, DAVAO DEL SUR
Project Duration : 180 Calendar Days

#### 2. CONCRETE ROAD Part No.

Pay Item No.	Description	Unit	Quantity	Unit Price	Amount (Passe)
ы	2	3	4	5	6
100(1)	Clearing & Grubbing (with Stripping)	ħ.	0.045	In words:	in words:
ŧ.	4			In figures:	In figures:
102(2)	Surplus Common Excavation	cu.m.	245.53	In words:	In words:
	8.		,		
				In figures:	In figures:
104(1)a	Embankment from roadway excavation (Common Soil)	cr.m	15.34	in words:	in words:
	ť:		:		
				In figures:	In figures:
105(1)a	Subgrade Preparation (Common Material)	sq.m.	598.15	in words:	In words:
1	X:	:			
			1	In figures:	In figures:
200(1)	Aggregate Subbase Course	cu.m	145.85	In words:	In words:
4.					
			1	In figures:	In figures:
311(1)b1 P	Portland Cement Concrete Pavement (Unreinforced), 200mm thk.	.w.ps	729.23	In words:	In words:
			,		
				In figures:	In figures:
Submitted by:	7:				

Name of the Representative of the Bidder	Date	
Position		
Name of Bridge		

Project Duration	Location of the Contract	Contract Name
: 180 Calendar Days	POBLACION, KIBLAWAN, DAVAO DEL SUR	: CONSTRUCTION AND IMPROVEMENT OF GREGORIO MATAS DISTRICT HOSPITAL

## 3. PERIMETER FENCE WITH SOLAR LIGHTS Part No.

Submitted by:	902 (1)a1	900 (1)c	804 (4)	803 (1)a	Pay Item No. 1 800 (2)
ν:	902 (1)a1 Reinforcing Steel (Deformed) Grade 40	900 (1)c Structural Concrete ,Class A, 3000 psi, 28 days	Gravel Fill	Structure Excavation (Common Soil)	Pay Description 1 2 2 800 (2) Clearing and Grubbing
	, ĕ	¢ œ.m.	cu.m.	cu.m.	Unit
	4289.61	46,71	12.20	104.26	Quantity 4 1.00
Date :	In words:	In words:	In words:	In words:	Unit Price {Pesos} 5 In words:
	In words:	In words:	In words:	In words:	Amount (Pesos) 6 In words:

Name of Bidder	Position	Name of the Representative of the Bidder
		Date :

Project Duration	Location of the Contract :	Contract Name
: 180	POB	<u>8</u>
: 180 Calendar Days	POBLACION, KIBLAWAN, DAVAO DEL SUR	CONSTRUCTION AND IMPROVEMENT OF GREGORIO MATAS DISTRICT HOSPITAL

## 3. PERIMETER FENCE WITH SOLAR LIGHTS Part No.

Pay Item No.	Description	Unit	Quantity	Unit Price (Pesos)	Amount (Pesos)
1	2	ω	4	5	6
903 (2)	Formworks and Falseworks	sq.m.	373.86	In words:	In words:
(Ban)		£		- Alleinanna - All	
	```		, , , , , ,	In figures:	In figures:
1046(2)a1	1046(2)a1 CHB Non Load Bearing (including Reinfording Steel),100 mm	.m.ps	623.18	In words:	In words:
•		4,		and a second a second and a second a second and a second	a de la constanta de la consta
				In figures:	In figures:
1027 (1)	Cement Plaster Finish	sq.m.	1,510.76	√ln words:	in words:
		٠			
				In figures:	In figures:
1047(1)	1047(1) Structural Steel	l.s.	1:00	In words:	in words:
1			400	Committee of the Commit	
			· · · · · · · · · · · · · · · · · · ·	In figures:	In figures:
					1 - 1 - 1 - 1 - 1 - 1 - 1 - 1 - 1 - 1 -
1032(1)a	1032(1)a Painting Works, Masonry/Concrete	sq.m.	1510.76	In words:	In words:
\\	(		ķ		
		\. 		In figures:	In figures:
Submitted by:	by:				
				Date :	

Name of Bidder	Position	Name of the Representative of the Bidder
		Date :

Contract Name	-	ION AND I	MPROVEM	CONSTRUCTION AND IMPROVEMENT OF GREGORIO MATAS DISTRICT HOSPITAL	ral .
Location of the C Project Duration	Location of the Contract : POBLACION, KIBLAWAN, DAVAO DEL SUR Project Duration : 180 Calendar Days	KIBLAWA r Days	N, DAVAO	DELSUR	
			BILL O	BILL OF QUANTITIES	
3. PERIME	3. PERIMETER FENCE WITH SOLAR LIGHTS Part No.				
Pay	Description	Unit	Ouantity	Unit Price	Amount
Item No.	J.	٠ ;	4	(Pesos)	(Pesos)
ŀ	ı	,	4	c	
1032(1)c	1032(1)c Painting Works, Steel	sq.m,	236.06	in words:	In words:
	******	<u>, , , , , , , , , , , , , , , , , , , </u>	١		
<i>P</i>				In figures:	In figures:
624(8)	Solar LED Street Light (Integrated Street Light)	each	34.00	In words:	in words:
<b>X.</b>			1		
			······································	In figures:	In figures:
ubmitted by:	by:				
ame of th	ame of the Representative of the Bidder			Date :	
	:				
osition	- CALLAND AND AND AND AND AND AND AND AND AND				

### 4. CADAVER HOLDING AREA Part No.

Submitted by:		*.	903(2)	1,	\	902(1)a1		d.	900(1)c		<i>k_</i>	804(7)		K	803(1)a	ħ	·.	800(2)	1	Pay Item No.
y:		* .	Formworks and Falseworks		t.	902(1)a1 Reinforcing Steel (Deformed) Grade			Structural Concrete, Class A,3000 psi, 28 Days		1	Gravel Fill	î		Structure Excavation, (Common Soil)	i	3	Clearing and Grubbing	2	Description
			1.5.			kgs.			cu.m.	 		cu.m.	(		си.т.			<u>'</u>	w	Unit
		<b>\</b>	1.00			839.03			11.76		1	8.02		· N	7.95		, j	1.00	4	Quantity
	In figures:		in words:	In figures:		In words:	In figures:		In words:	In figures:		in words:	In figures:		In words:	In figures:		In words:	5	Unit Price (Pesos)
	In figures:		In words:	In figures:		In words:	In figures:		In words:	In figures:		In words:	In figures:		In words:	In figures:		In words:	6	Amount (Pesos)

The state of the s	Date	••	
Name of the Representative of the Bidder			
Position			
Name of Bidder			

Contract Name	: CONSTRUCTION AND IMPROVEMENT OF GREGORIO MATAS DISTRICT HOSPITAL
Location of the Contract	POBLACION, KIBLAWAN, DAVAO DEL SUR
Project Duration	: 180 Calendar Days

#### 4. CADAVER HOLDING AREA Part No.

Pay Description	Unit	Quantity	Unit Price	Amount
	ω	4	(Pesos) 5	(Pesos)
1001(11) Septic Vault	.5.	1.00	In words:	In words:
^		,'\	In figures:	in figures:
				ाः । स्या द्वा
1002(4) Plumbing Fixtures	ls.	1.00	in words:	In words:
\ \ \ \ \ \ \ \ \ \ \ \ \ \ \ \ \ \ \			In figures:	In figures:
			Wildowski da	
1002(24) Cold Water Lines		1.00	in words:	In words:
\	<i>(</i> -			
			In figures:	In figures:
1002(27) Plumbing Works	-  -	1,00	In words:	In words:
				444
			In figures:	In figures:
1003(1)b1 4.5mm Fiber Cement Board on Metal Frame Ceiling	sq.m.	68.34	in words:	In words:
ř.		1		
			In figures:	In figures:
1003(2)f Wall, Metal Cladding	sq.m.	7.86	In words:	In words:
<b>,</b>		:		
			In figures:	In figures:
Submitted by:				
Name of the Representative of the Bidder			Date :	

	٠
Name of the Representative of the Bidder	
Position	
Name of Bidder	

		411			
Contract Name		ION AND	IMPROVEN	CONSTRUCTION AND IMPROVEMENT OF GREGORIO MATAS DISTRICT HOSPITAL	TAL
Location of the C Project Duration	Location of the Contract : POBLACION, KIBLAWAN, DAVAO DEL SUR Project Duration : 180 Calendar Days	, KIBLAW,	AN, DAVAO	DELSUR	
			BILLC	BILL OF QUANTITIES	
4. CADAVE	4. CADAVER HOLDING AREA Part No.				
Pay Item No.	Description	Unit	Quantity	Unit Price	Amour
1	2	ω	42	5	6
1003 (17)	Carpentry & Joinery Works	1,5.	1.00	In words:	in words:
	Ą.		1		
^				In figures:	in figures:
1008(1)a	Aluminum Glass Window (Sliding	sq.m.	4.32	In words:	In words:
	Type)		1		THE STATE OF THE S
1	1		:	In figures:	In figures:
1010(1)	Frames (Jambs, Sills, Head Transoms and Mullions)	set	6.00	In words:	In words:
1	£ .	,,			
				in figures:	In figures:
1010(2)6	Doors (Wood Panel)	sq.m.	2.73	in words:	In words:
				In figures:	In figures:
1013 (2) a1 F	1013 (2) a1 Fabricated Metal Roofing Accessory (Gauge 26 (0.551 mm), Ridge Roll)	sq.m.	10.30	in words:	In words:
	``\	1			
			1	In figures:	In figures:
				The second secon	
1014(1)b2 P	Pre-painted Metal Sheets, above 0.427 mm, Rib Type, Long Span	sq.m.	80.77	in words:	in words:
No.		, ,	1		
-				In figures:	In figures:
Submitted by:	у:				
Name of the	Name of the Representative of the Bidder			Date :	
Position					

Name of Bidder

Contract Name

CONSTRUCTION AND IMPROVEMENT OF GREGORIO MATAS DISTRICT HOSPITAL
Location of the Contract
POBLACION, KIBLAWAN, DAVAO DEL SUR
Project Duration
180 Calendar Days

#### BILL OF QUANTITIES

4. CADAVER HOLDING AREA Part No.

Submitted by:	1038(1) R	1032(1)c P	1032(1)6	1032(1)a	1027(1)	Pay Item No. 1 1018 (5)
	Reflective Insulation	1032(1)c Painting Works, Metal	1032(1)b Paipeng Works, Wood	1032(1)a Painting Works, Masonny/Concrete	Cement Plaster Finish	Description 2 Glazed Tiles
			3		Ĭ,	
	sq.m.	, sq.m.	sq.m.	yg'w'	sq.m.	Unit 3 sq.m.
	68.34	,4 ,4 8	16.98	268.34	200.00	Quantity 4 38.40
	In figures:	In words:	In words:	มหาพ์ords: In figures:	In figures:	In words:
Date :						(Pesos) 5
	In words:	In words:	In words:In figures:	in words:	in words:	Amount (Pesos) 6 In words:

Position Name of Bidder Name of the Representative of the Bidder

Contract Name	
CONSTRUCTION AND IMPROVEMENT OF GREGORIO MATAS DISTRICT HOSPITAL	

Project Duration : POBLACION, KIBLAWAN, DAVAO DEL SUR
: 180 Calendar Days

### BILL OF QUANTITIES

#### 4. CADAVER HOLDING AREA Part No.

Submitted by:	1103 (1) Lighting Fixtures	1102 (1) Par	1101(33) Wi	1100 (10) Co	1047 (1) St	Pay litem No. 1 1046(2)a1 Cl
	tting Fixtures	1102 (1) Panelboard with Main & Branch Breakers	1101(33) Wires and Wiring Devices	1100 (10) Copduits, Boxes & Fittings (Conduit Works/Conduit Rough-In)	Structural Steel	Pay Description  1 2  1046(2)a1 CHB.Non-Load Bearing(Including feinforcing Steel),100mm
	<u> </u>	.5.	, <del>,</del>		J.S.	Unit
	1.00	1.00	1.00	1.00	00.1	Quantity 4 109,49
Date :	In words:	in words:	In words:	In words:	Ip-words:	Unit Price (Pesos) 5 5 In figures:
	In words:	in words:	In words:	In words:	In words:	Amount (Pesos) 5 6 In words: In figures:

Position Name of Bidder Name of the Representative of the Bidder

Location of the Contract Project Duration	Contract Name
: 180 Calendar Days	CONSTRUCTION AND IMPROVEMENT OF GREGORIO MATAS DISTRICT HOSPITAL

#### 5. PRAYER ROOM Part No.

Position	Name of the Representative of the Bidder	Date	
	Position		

Project Duration	Location of the Contract		Contract Name	
: 180 Calendar Days	POBLACION, KIBLAWAN, DAVAO DEL SUR	Management of the control of the con	: CONSTRUCTION AND IMPROVEMENT OF GREGORIO MATAS DISTRICT HOSPITAL	

5. PRAYER ROOM
Part No.

				1. 2000/
2	3	4	5	6
	lump sum	1.00	In words:	In words:
		\		
			In figures:	In figures:
⇒painted Metal Sheets, above 27 mm, Rib Type, Long Span	sq. m.	36_11	In words:	in words:
	ų.	V.		
			In figures:	In figures:
glazed Tiles	sq. m.	24.00		In words:
		1		
,				In figures:
iting Works, Wood	э sg. эз	38.32	In words:	In words:
			Addition to the state of the st	
			In figures:	In figures:
ting Works, Steel	sq. m.	57.80	lp-words:	in words:
	_	^		
			In figures:	In figures:
		·		
ctural Steel	is,	1.00	n words:	In words:
	\			
•			In figures:	In figures:
		<del>-</del>		
oresentative of the Bidder				
	heets, above, Long Span	an ve	sq. m.  sq. m.  sq. m.	1.00   In words:

Pasition Name of Bidder

jud 4	Pay Item No.	5. PRAYER ROOM Part No.		Location of the ( Project Duration	Contract Name
2	Description	MOOM		Project Duration : POBLACION, KIBLAWAN, DAVAO DEL SUR  180 Calendar Days	
ω	Unit			N, KIBLAW lar Days	TION AND
4	Quantity		BILL C	AN, DAVAO	IMPROVEN
S <sub>1</sub>	Unit Price (Pesos)		BILL OF QUANTITIES	DELSUR	CONSTRUCTION AND IMPROVEMENT OF GREGORIO MATAS DISTRICT HOSPITAL
א	Amount (Pesos)				ITAL

Name of Bidder Position Name of the Representative of the Bidder Date

Submitted by:

SPL-1

Acrylic Signages

S

1.00

In-words:

In words:

In figures:

In figures:

Project Duration	Location of the Contract		Contract Name
: 180 Calendar Days	POBLACION, KIBLAWAN, DAVAO DEL SUR	The state of the s	: CONSTRUCTION AND IMPROVEMENT OF GREGORIO MATAS DISTRICT HOSPIT

### 6. DRAINAGE/CANAL WITH COVER Part No.

:	\	503(1)		1	405(1)c1				404(1)a		^	103(1)	ц	Pay Item No.
		Metal Frame and Grating		1	405(1)c1 Structural Concrete Class "B" (7 days)	***************************************	r		Reinforcing Steel Bar, Grade 40 (Minor Structures)		\	Structure Excavation	2	Description
ļ		Set		<u> </u>	Cum.			1	ķ			cu.m.	w	Unit
	(	225.00		1	85.35			`	2541.46		\	160.03	4	Quantity
	In figures:	In words:	In figures:		in words:		In figures:		in words:	In figures:		In words:	5	Unit Price (Pesos)
1994	In figures:	in words:	In figures:		In words:	THE PROPERTY OF THE PROPERTY O	In figures:		In words:	In figures:		In words:	6	Amount (Pesos)

	,	<i>r</i> .				
					In figures:	In figures:
	-	WWW.			170000111111111111111111111111111111111	
	405(1)c1	405(1)c1 Structural Concrete Class "B" (7 days)	cu.m.	85.35	in words:	In words:
	\		<b></b> .	1		7/440-1
	^				10.7	
					In figures:	In figures:
					T T T T T T T T T T T T T T T T T T T	
	503(1)	Metal Frame and Grating	set	225.00	In words:	In words:
			(	\	2000	
	_			(	In figures:	In figures:
				· · · · ·		
						***************************************
10	Submitted by:	.ye			Date :	
	dame of the	Name of the Representative of the Bidder				
n !	Position					

Name of Bidder

17 of 19

	1			
Contract Name	: CONSTRUCTION AN	DIMPROVEN	: CONSTRUCTION AND IMPROVEMENT OF GREGORIO MATAS DISTRICT HOSPITAL	ITAL
Location of the Contract: Project Duration	POBLACION, KIBLAWAN, DAVAO DEL SUR 180 Calendar Days	VAN, DAVAO	DELSUR	
		BILL (	BILL OF QUANTITIES	
7. LANDSCAPING Part No.				
Pay Description	on Unit	Quantity	Unit Price	Amount
1 2	3	4		6
803(1)a Structure Excavation	cu.m.	17.10	in words:	In words:
			In figures:	In figures:
SPL Landscaping	mps	38.00	In words:	In words:
			In figures:	In figures:
submitted by:				
lame of the Representative of the Bidder	Bidder	·	Date :	
osition		'		

Name of Bidder

	V, KIBLAW	AN, DAVAO	DELSUR	
	ar Days			
		BILL C	OF QUANTITIES	
8. CONCRETE PATHWAY Part No.	•			
Description	Unit	Quantity	Unit Price (Pesos)	Amou (Peso
2	3	4	5	6
Clearing & Grubbing	lumpsum	1.00	In words:	In words:
٨			In figures:	In figures:
Surplus Common Excavation	cu.m.	33.96	In words:	In words:
				100000000000000000000000000000000000000
			In figures:	In figures:
Gravel fill	cm.m	12.48	lp.words:	In words:
		\		
			In figures:	In figures:
			- Interpretation of the control of t	
900(1)b1 Structural Concrete, Class A, 14 Days	cu.m	22.20	In words:	in words:
\.		\		
٨			In figures:	In figures:
rcing Steel (Deformed ), Grade	kg.	472.50	In words:	In words:
~? <sub>\$\dagga</sub>				
,			In figures:	In figures:
	Project Duration : POBLACION Project Duration : 180 Calend   180 Calen	on : 180 Calendar Days  THWAY  Description Unit  2 3  ng & Grubbing lumpsum  fill cu.m.  fill cu.m.  fill cu.m.  cu.m.  fill cu.m.	Unit Quar Days  Cu.m.  Cu.m.  Cu.m.  1	BILL OF QUANTITIES  BILL OF QUANTITIES  S  Unit Price (Pesos)  In figures:  Cu.m. 33.96 In words:  Cu.m. 12.48 Ipwords:  In figures:  In figures:  In figures:  In figures:  In figures:

Name of Bidder

## SECTION X.

# AND FINANCIAL DOCUMENTS CHECKLIST OF TECHNICAL

I\_

## AWARDS COMMITTEE AGEMENT

AUS 130 Mobile Nos. 0905-229-0526/0908-332-2024 (Goods), 0948-768-5848 (Infra)
Telefax: (082) 553-9579
Website: www.davaodelsur.gov.ph/pgo-bac
Email Add: bac.davaodelsur2@gmail.com/sbacdavaodelsur@gmail.com/

## CHECKLIST-CIVIL

į	ï	j
ć		
-		

Opening of Bids:

Project Requirements, which shall include the following:     a. Organizational chart for the contract to be	1. Original copy of Bid Security in the form of the following:  □ Cash or Cashier's/ Manager's check (2%)  □ Bank Guarantee/ Draft or Irrevocable Letter of Credit  □ Surety Bond callable upon demand (5%)  □ Bid Securing Declaration (in the prescribed form)	a. For Infrastru Agreement in Agreement in shall submit t Section 8.5.2 documents by the partner re of its ongoing	e. The prospective bidder's cc case of procurement of Go Commercial Bank, in lieu of 2 Class "B" Documents	1	c. Statement of the bidder's Single Largest C for the last (3) years, and whose value, indices, must be at least fifty percent (50% under Small A and Small B categories will allowed to bid if the cost of such contract (ARCC) of their registration based on the must be supported with the following:  Acceptance or Inspection Report or Performance Evaluation System (CPES) in		a. Valid PhilGEPS Registrati	1.   Class "A" Documents	ENVELOPE 1- ELIGIBILITY DOCUMENTS/TECHNICAL	Address:	Name of Contractor/Supplier:	PR: Dated:	Name of Project/Brief Description of Goods:
ments, which shall include the following: Organizational chart for the contract to be bid	riginal copy of Bid Security in the form of the following: Cash or Cashier's/ Manager's check (2%) Bank Guarantee/ Draft or Irrevocable Letter of Credit (2%) Surety Bond callable upon demand (5%) Bid Securing Declaration (in the prescribed form)	For Infrastructure Projects, Joint Venture bidders shall submit a Joint Venture Agreement in accordance with R.A. 4566 and its IRR. Each partner of the joint venture shall submit their respective PhilGEPS Certificates of Registration in accordance with Section 8.5.2 of this IRR. The submission of technical and financial eligibility documents by any of the joint venture partners constitutes compliance: Provided, that the partner responsible to submit the NFCC shall likewise submit the Statement of all of its ongoing contracts and Audited Statements.	The prospective bidder's computation of Net Financial Contracting Capacity (NFCC). However, in the case of procurement of Goods, a bidder may submit a committed Line of Credit from a Universal or Commercial Bank, in lieu of its NFCC computation. (Note: K=15)	Valid Philippine Contractors Accreditation Board (PCAB) License or Special PCAB License in case of Joint Ventures, and Registration for the type and cost of the contract to be bid.	Statement of the bidder's Single Largest Completed Contract (SLCC) similar to the contract to be bid for the last (3) years, and whose value, adjusted to current prices using the PSA consumer price indices, must be at least fifty percent (50%) of the ABC to be bid: Provided, however, that contractors under Small A and Small B categories without similar experience on the contract to be bid may be allowed to bid if the cost of such contract is not more than the Allowable Range of Contract Cost (ARCC) of their registration based on the guidelines as prescribed by the PCAB. This Statement must be supported with the following: Contract/ Purchase Order, Certificate of Completion/ Acceptance or Inspection Report or Official Receipt, Validated Contractors/Constructors Performance Evaluation System (CPES) in DPW/H website	Statement of the prospective bidder of all its on-going government and private contracts, including contracts awarded but not yet started (7 calendar days before the bid opening), if any, whether similar or not similar in nature and complexity to the contract to be bid with supporting documents such as Notice of Award and/or Contract, Notice to Proceed, and Certificate of Accomplishment or Statement of Time Elapsed and Work Accomplished.	Valid PhilGEPS Registration Certificate (Platinum Membership) with its corresponding Annex A.	S	NICAL		End User.	ABC	Spring of Fig.

1. Duly Sig 2. Duly Sig 3. Duly Sig 4. Duly Sig	D	0										
1. Duly Signed Financial Bid Form 2. Duly Signed Bid Prices in the Bill of Quantities 3. Duly Signed Detailed Estimates 4. Duly Signed Cash Flow by Quarter and Payment Schedules	DISQUALIFIED	QUALIFIED	Duly Notarized Certification as to Compliance to Labor Laws and Standard	Duly Notarized Affidavit of Site Inspection		• Pert-CPM	Construction schedule and S-Curve	Construction Methods	4. Other documents/materials to comply with other non-discretionary criteria and requirements as stated in the Instruction to Bidders:	3. Original Duly Signed Omnibus Sworn Statement (OSS) by the prospective bidder or its duly authorized representative; and if applicable, Original Notarized Secretary's Certificate in case of a corporation, partnership, or cooperative; or Original Special Power of Attorney of all members of the joint venture giving full power and authority to its officer to sign the OSS and do acts to represent the bidder.	<ul> <li>List of contractor's equipment units, which are owned, leased, and/or under purchase agreements, supported by certification of availability of equipment from the equipment lessor/vendor for the duration of the project;</li> </ul>	<ul> <li>List of contractor's personnel (viz., Project Manager, Project Engineers, Materials Engineers, and Foremen), to be assigned to the contract to be bid, with their complete qualifications and experience data;</li> </ul>

- Purchase Request
- 22 Statement of all On-going Government & Private Contracts including Contracts awarded but not yet started (Prescribed Form)
- Statement of Single Largest Completed Contract (Prescribed Form)
- 0400 Bid Securing Declaration (Prescribed Form)
  - Omnibus Sworn Statement (Prescribed Form)
- Bid Form (Prescribed Form)
- Resolution No. 1333 Series of 2023 / Three-Strike Policy Resolution No. 052 Series of 2022 Resolution No. 053 Series of 2022
- 10) TWG - Checklist for Bid Evaluation
- TWG Checklist for Post Qualification

## PURCHASE REQUEST

## PROVINCE OF DAYAO DEL SUR MATTI, DIGOS CITY

		4/16 N OFF 3 3 3 3 3 3 3 3 3 3 3 3 3 3 3 3 3 3	December 11, 2023	te	Date
Governor		Provincial Treasurer	Towncor Engineer		T
YVONNE RONG CAGAS	NOAA	FARAH GENIVIA V. BIDAN, CPA	LEONERLIMARCH'S SUARIO	Printed Name Designation	28
1888 Assal		Confident		].,	98
APPROVED :	A	CASH AVAILABILITY			T
UT I AF		IN, DAVAO DEL SUR	located at POBLACION, KIBLAWAN, DAVAO DEL SUR	1 15	
SPITAI	DISTRICT HO	For use in the CONSTRUCTION AND IMPROVEMENT OF GREGORIO MATAS DISTRICT HOSPITAL	or use in the CONSTRUCTION A	Purpose/Remarks F	Ę
		io Matas District Hospital	Charge to: Construction and Improvement of Gregorio Matas District Hospital Poblacion, Kiblawan, Davao del Sur CY 2022 SUPPLEMENTAL NO. 5 89 19403 Happ Half X Hanking Charles	Charge to: C	
TECHNICAL WORKING GROUP TECHNICAL SPECS CONTROLLED BY: DAGE:	TECHNICAL SI	TEC TEC BY: DAGE			
9,250,000.00 vvvvvvvv	· · · · · · · · · · · · · · · · · · ·	CY TOTAL	XXXXXXXXXXXX		
	Н	CONSTRUCTION AND IMPROVEMENT OF GREGORIO MATAS DISTRICT HOSPITAL located at POBLACION, KIBLAWAN, DAVAO DEL SUR all in accordance, to plans, specifications and scope of work and the Green Procurement Policy as adopted by Executive Order No. 30 series of 2019.	CONSTRUCTION AND IMPRIDISTRICT HOSPITAL located DEL SUR all in accordance, twork and the Green Procure Order No. 30 series of 2019.	1 Job Order	
UNIT COST TOTAL COST	UI VID	ITEM DESCRIPTION		STOCK UNIT OF	
••	SAI NO. :		Construction	section	*
PR NO. : 003-24-5 Date : 62/6/1/20	PR NO. : 00		CONTRICTED CONTRICTED	Ĩ	



### Statement of all On-going Government & Private Contracts including Contracts awarded but not yet started

***		:կդյ۸						Total Cost		d
		I			т—					
					+					
					+					
			-		4					
əjevi										
					<del>                                     </del>					
overnment					<u> </u>		2324 102241100 228224	Planned	IsutoA	noitroq
c)Telephoi	c)Telephone No.	Mork	Descrip	noitqi	%	noiteruO (d	c)Target Completion Date	Accomplis	<u></u>	Works/Undelivered
Contract / Location b) Address	b)Address	1 1	ດກາດ	ider's Rol	l l	a) Amount at award	b)Date Started	i	1	Salue of Outstanding
Name of sowners	a)Owner's Name	Nature of	Pid	Ind o'wold!	"	- •	a)Date Awarded	0%	<u> </u>	anillandatiiQ 30 quiloV

2. Notice to Proceed issued by the Procuring Entity

3. Certificate of Accomplishments signed by the owner or authorized representative

Date		
Designation	L L	
	ngi2 & smsN bətrint9)	
Submitted by		-

		3 years)	e tor the Last	(Similar in Natur
Contract (SLCC)	Completed	Largest	of Single	Statement

					s supported with:	Note: This statement shall be
c) Date of Completion	House in a fa					
b) Date Started	c) Duration	<u>%</u>	Description	Work	c)Telephone No.	1502 122[01   11012202
bэртвwA эзвQ (в	brewA ts truomA (s noitelqmoD ts truomA (d	Role	Bidder's	Nature of	a)Owner's Name b)Address	Vame of Contract / Location Project Cost
	.on ai					Name of Project/Contract:

1. Contract/Purchase Order

2. Certificate of Completion/Acceptance or Inspection and Acceptance Report or Official Receipts

	Date:
(Printed Name & Signature)	Designation:
	$-$ : $\lambda$ g pə $\mu$ jugns

Bid Securing Declaration Form Ishall be submitted with the Bid if bidder opts to provide this form of bid security]

### Project Identification No.: [Insert number] BID SECURING DECLARATION

To: [Insert name and address of the Procuring Entity]

I/We, the undersigned, declare that:

- I//Ve understand that, according to your conditions, bids must Security, which may be in the form of a Bid Securing Declaration. bids must be supported by a Bid
- Ņ I/We accept that: (a) I/we will be automatically disqualified from bidding for any procurement contract with any procuring entity for a period of two (2) years upon receipt of your Blacklisting Order; and, (b) I/we will pay the applicable fine provided under Section 6 of the Guidelines on the Use of Bid Securing Declaration, within fifteen (15) days from receipt of the written demand by the procuring entity for the commission of acts resulting to the enforcement of the bid securing declaration under Sections 23.1(b), 34.2, 40.1 and 69.1, except 69.1(f) of the IRR of RA No. 9184; without prejudice to other legal action the government may undertake
- ω I/We understand that this Bid Securing Declaration shall cease to be valid on the following circumstances:
- ത request; Upon expiration of the bid validity period, or any extension thereof pursuant to your
- Ö effect, and (i) I/we failed to timely file a request for reconsideration or (ii) I/we filed a waiver to avail of said right; and I am/we are declared the bidder with the Lowest Calculated Responsive Bid, and I am/we are declared ineligible or post-disqualified upon receipt of your notice to such
- Ω I/we have furnished the performance security and signed the Contract

[year] at [place of execution]. IN WITNESS WHEREOF, I/We have hereunto set my/our hand/s this day of [month]

[Insert NAME OF BIDDER OR ITS AUTHORIZED [Insert signatory's legal capacity] Affiant REPRESENTATIVE

[Jurai] [Format shall be based on the latest Rules on Notarial Practice]

# **Omnibus Sworn Statement (Revised)**

[shall be submitted with the Bid]

CITY/MUNICIPALITY OF)	REPUBLIC OF THE PHILIPPINES)
S.S.	

### AFFIDAVIT

that I, [Name of Affiant], of legal age, [Civil Status], [Nationality], and residing at [Address of Affiant], after having been duly sworn in accordance with law, do hereby depose and state

[Select one, delete the other:]

[If a sole proprietorship:] I am the sole proprietor or authorized representative of [Name of Bidder] with office address at [address of Bidder];

[If a partnership, corporation, cooperative, or joint venture:] I am the duly authorized and designated representative of [Name of Bidder] with office address at [address of Bidder];

2. [Select one, delete the other:]

attached duly notarized Special Power of Attorney; all acts necessary to participate, submit the bid, and to sign and execute the ensuing contract for [Name of the Project] of the [Name of the Procuring Entity], as shown in the of [Name of Bidder], I have full power and authority to do, execute and perform [If a sole proprietorship:] As the owner and sole proprietor, or authorized representative

showing proof of authorization (e.g., duly notarized Secretary's Certifica Board/Partnership Resolution, or Special Power of Attorney, whichever is applicable;)]; bid, and to sign and execute the ensuing contract for [Name of the Project] of the [Name of the Procuring Entity], as shown in the attached [state title of attached document authority to do, execute and perform any and all acts necessary to participate, submit the [If a partnership, corporation, cooperative, or joint venture:] I am granted full power and authorization notarized Secretary's Certificate,

- လ relation, membership, association, affiliation, or controlling interest with another blacklisted person or entity as defined and provided for in the Uniform Guidelines on Blacklisting; foreign government/foreign or international financing institution whose blacklisting rules have been recognized by the Government Procurement Policy Board, by itself or by [Name of Bidder] is not "blacklisted" or barred from bidding by the Government of the Philippines or any of its agencies, offices, corporations, or Local Government Units,
- 4. Each of the documents submitted in satisfaction of the bidding requirements is therein are true and correct; authentic copy of the original, complete, and all statements and information provided 2
- Ċı [Name of Bidder] is authorizing the Head of the Procuring Entity or its duly authorized representative(s) to verify all the documents submitted;
- 6. [Select one, delete the rest:]

[If a sole proprietorship:] The owner or sole proprietor is not related to the Head of the Procuring Entity, members of the Bids and Awards Committee (BAC), the Technical

Working Group, and the BAC Secretariat, the head of the Project Management Office or the end-user unit, and the project consultants by consanguinity or affinity up to the third civil degree;

[If a partnership or cooperative:] None of the officers and members of [Name of Bidder] is related to the Head of the Procuring Entity, members of the Bids and Awards Committee (BAC), the Technical Working Group, and the BAC Secretariat, the head of the Project Management Office or the end-user unit, and the project consultants by consanguinity or affinity up to the third civil degree

stockholders of [Name of Bidder] is related to the Head of the Procuring Entity, members of the Bids and Awards Committee (BAC), the Technical Working Group, and the BAC Secretariat, the head of the Project Management Office or the end-user unit, and the project consultants by consanguinity or affinity up to the third civil degree; corporation or joint venture: J None of the officers, directors, and controlling

- 7 [Name of Bidder] complies with existing labor laws and standards; and
- œ compliance with the Philippine Bidding Documents, which includes [Name of Bidder] is aware of and has undertaken the responsibilities Ø Bidder
- Carefully examining all of the Bidding Documents;
- Ö Contract; Acknowledging all conditions, local or otherwise, affecting the implementation of the
- 0 Making an estimate of the facilities available and needed for the contract to be bid, if any; and
- Ω. Inquiring *Project]*. or securing Supplemental/Bid Bulletin(s) issued for the [Name of the
- ဖွ or representative of the government in relation to any procurement project or activity. or any form of consideration, pecuniary or otherwise, to any person or official, personnel [Name of Bidder] did not give or pay directly or indirectly, any commission, amount, fee
- Ş In case advance payment was made or given, failure to perform or deliver any of the obligations and undertakings in the contract shall be sufficient grounds to constitute criminal liability for Swindling (Estafa) or the commission of fraud with unfaithfulness or abuse of confidence through misappropriating or converting any payment received by a person or entity under an obligation involving the duty to deliver certain goods or services, to the prejudice of the public and the government of the Philippines pursuant to Article 315 of Act No. 3815 s. 1930, as amended, or the Revised Penal Code.

	7
	WINESS
, Philippines.	WHEREOF, I have hereunto set my hand this
	ha
	6
	hereunto
	set
	Ψ
	hand
	this
	욨
	بر of
	Ĺ
	20 at
	핰

[Insert NAME OF BIDDER OR ITS AUTHORIZED REPRESENTATIVE] [Insert signatory's legal capacity] Affiant

Jurati

[Format shall be based on the latest Rules on Notarial Practice]

## Bid Form for the Procurement of Infrastructure Projects [shall be submitted with the Bid]

BIDFORM

	Project Identification No. :	
1		
	Date :	

To: [name and address of Procuring Entity]

acknowledged, we, the undersigned, declare that: Having examined the Philippine Bidding Documents (PBDs) including the Supplemental or Bid Bulletin Numbers *[insert numbers]*, the receipt of which is hereby duly Having examined the Philippine Bidding

- for the Procurement Project: [insert name of contract]; We have no reservation to the PBDs, including the Supplemental or Bid Bulletins,
- Ö We offer to execute the Works for this Contract in accordance with the PBDs;
- ဂ္ဂ The total price of our Bid in words and figures, excluding any discounts offered below is: [insert information];
- ρ information]; The discounts offered and the methodology for their application are: *[insert*
- Ō reflected in the detailed estimates, The total bid price includes the cost of all taxes, such as, but not limited to: [specify the applicable taxes, e.g. (i) value added tax (VAT), (ii) income tax, (iii) local taxes, and (iv) other fiscal levies and duties], which are itemized herein and
- 7 Our Bid shall be valid within the a period stated in the PBDs, and it shall remain binding upon us at any time before the expiration of that period;
- ά of issued GPPB guidelines<sup>1</sup> for this purpose If our Bid is accepted, we commit to obtain a Performance Security in the amount of *[insert percentage amount]* percent of the Contract Price for the due performance of the Contract, or a Performance Securing Declaration in lieu of the the allowable forms of Performance Security, subject to the terms and conditions
- ₽ We are not participating, as Bidders, in more than one Bid in this bidding process other than alternative offers in accordance with the Bidding Documents;
- :--We understand that this Bid, together with your written acceptance thereof included in your notification of award, shall constitute a binding contract between us, until a formal Contract is prepared and executed; and
- ÷. We understand that you are not bound to accept the Lowest Calculated Bid or any other Bid that you may receive
- $\overline{\phantom{a}}$ V⁄e likewise certify/confirm that the undersigned, ζŎ. # He duly authorized

<sup>&</sup>lt;sup>1</sup> currently based on GPPB Resolution No. 09-2020

representative of the bidder, and granted full power and authority to do, execute and perform any and all acts necessary to participate, submit the bid, and to sign and execute the ensuing contract for the [Name of Project] of the [Name of the Procuring Entity].

We acknowledge that failure to sign each and every page of this Bid Form, including the Bill of Quantities, shall be a ground for the rejection of our bid.

Name:
Legal Capacity:
Signature:
Duly authorized to sign the Bid for and behalf of:
Date:

### Resolution No.1333 Series of 2023

DEL SUR. PROCUREMENT OF CONTRACTS FOR GOODS AND SERVICES YVONNE ROÑA CAGAS TO FURTHER PROCUREMENT OF CONTRACTS F RECOMMENDING 5 H HEAD OF **A RESOLUTION** ER AMEND THE 3-STRIKE POLICY IN THE FOR GOODS AND SERVICES DAVAO

WHEREAS, the Provincial Government of Davao del Sur encounters several failures of biddings due to constant errors committed by the participating Bidders in the Conference and the Instruction to Bidders; submission of their bidding documents despite of the orientation during

Government of Davao del Sur against violations of Section 69 of the IRR of RA 9184; WHEREAS, to further strengthen the integrity of the competitive bidding process, the Bids and Awards Committee unanimously agreed that the following instructions are hereby issued pertaining to the implementation of the 3-Strike Policy of the Provincial

of the The provision of Section 69.1 of the said IRR, pertaining to the 3-Strike Policy Provincial Government of Davao del Sur, is hereby reiterated as

where applicable, for the following violations: 69.1.i All other acts that tend to from bidding, submitting late Bids or patently insufficient bid, for at least three defeat the purpose of the competitive bidding, such as habitually withdrawing process, as well as disqualification from further competitive bidding being undertaken by the Procur years for the second offense from participating in the competitive bidding suspension for one (1) year for the first offense, and suspension of two (2) shall impose on bidders or prospective bidders, the administrative penalty of the Procuring Entity, subject to the authority delegated to the BAC, if any, (3) times within a year, except for valid reasons." "In addition to the provisions of Rules XXI and XXII of this IRR, the Head of Procuring Entity concerned, participating

- N The violations enumerated, which are considered as acts that tend to defeat the purpose of competitive bidding, are hereby clarified to read as follows:
- Non-submission of post-qualification and other requirements prescribed period as specified in the notice issued by the BAC; within the
- 9 All other acts that tend to defeat the purpose of competitive bidding, such
- 1.) Withdrawing from bidding or Non-dropping of Bid Documents
- Submitting late Bids;
- Submitting clarified as the "total absence" of the required document. 앜 patently insufficient bid. Patently insufficient bid ত

BAC RES. NO. 1333, S.2023 4.) Refusal to receive/acknowledge notice/s issued by the Head of the Procuring Entity and/or Bids and Awards Committee

X-X-X-X-X-X-X-X-X-X-X-X-X-X

- Habitually committing offenses that are not grounds for disqualification such as improper sealing, non-tabbing, and the like.
- ω and giving him three (3) calendar days to show cause why he should not be sanctioned for committing an act which tends to defeat the purpose of public bidding under the 3-Strike Policy of the Provincial Government of Davao del Every time a bidder is observed to have done committed any of the acts enumerated under Item 2 of this Resolution, the Chairperson of the BAC shall immediately issue a Show Cause Order to the erring bidder informing of his act,
- 4 Based on the evaluation by the BAC of the bidder's response to the Cause Order mentioned in Item No. 3 of this Resolution, the BAC shall, within five (5) calendar days from the receipt of the bidder's response determine whether the bidder's act was done with or without a valid cause;
- The BAC Secretariat shall submit to the BAC a 3-Strike Policy Report, which shall contain the information in Item 3 and 9 of this Resolution.
- The BAC through its Secretariat shall monitor the participation of bidders in all the said policy in other offices of the Provincial Government of Davao del Sur; the 3-Strike Policy in its jurisdiction as well as of the violations by the bidder of of its projects/participations, and maintain a tally of violations by each bidder of
- 7. All other petty defects found in the bid documents of the bidder which will not in the imposition of a strike, subject to the discretion of the BAC any manner defeat the purpose of Competitive Bidding shall not be a ground for
- methods of procurement, be it Competitive Bidding or alternative methods of procurement. For the procurement of Goods and Consulting Services, this For the procurement of Infrastructure Projects, this Policy is applicable to all Policy is applicable to Competitive Bidding only or alternative methods of
- 9. For the sanctions to be imposed:
- was disqualified during post-qualification stage with the same case of bidder with the same nature of violation opened on ONE (1) STRIKE will be imposed for various IB Nos. participated by the the same date, or
- different IB Nos. opened on the same date, or was disqualified during post-qualification stage with the same case of the latter; STRIKES fοr different discrepancies/offenses under
- For Item 2.c: Three habitual offenses are equivalent to one (1) strike
- <u> 1</u>0. Each "offense" by a bidder referred to in Section 69.1.i. of the IRR, as stated in "strikes" shall be observed in the succeeding year; Government of Davao del Sur. A Fresh Period of one (1) year in counting of calendar year Resolution, consists of three violations or strikes within a period of **one**

- Based on the Based on the 3-Strike reports, the Bids and Awards Committee, shall recommend to the Head of the Procuring Entity, for approval, the following administrative sanctions on the erring Contractor/Supplier for the violation of the 3-Strike Policy:
- For the first violation or strike a first warning.
- Ö
- O For the second strike – a second warning.
  For the third strike, which together with the first two strikes constitutes the first offense against the 3-Strike Policy – an administrative penalty of suspension for one (1) year from participating in any procurement process in the Provincial Government of Davao del Sur.
- Ω. participating in any procurement process in the Provincial Government For the second offense - the second set of three strikes committed by of Davao del Sur. an administrative suspension for two (2) years from

duly seconded by all BAC Members present it was WHEREFORE, on motion of BAC Member, Raul R. Fueconcillo, LAgri.MAgDev.

Procuring Entity, GOVERNOR YVONNE ROÑA CAGAS to FURTHER AMEND THE 3-STRIKE POLICY IN THE PROCUREMENT OF CONTRACTS FOR GOODS AND GOVERNMENT OF DAVAO DEL SUR. SERVICES, RESOLVED, AND as it is hereby RESOLVED, to recommend to the Head of the INFRASTRUCTURE **PROJECTS** QF. THE GOODS AND PROVINCIAL

concerned, Suppliers, and Concerned End Users, for their information and guidance RESOLVED FINALLY, to furnish copies of this Resolution to all agencies

Davao del Sur, this 31<sup>st</sup> day of August, 2023. RalotaCagas Sports and Business Complex, UNANIMOUSLY APPROVED at the Barangay Matti, Digos City, Province of Ralota Hall, Governor Douglas

BAC RES. NO. 1333, S.2023 Page -4-X-X-X-X-X-X-X-X-X-X-X-X

I hereby concur to the correctness of the minutes:

Engr. SHIELA MAE A. ZAPANTA, MPA
Administrative Officer IV, PMO
Head, BAC Secretariat for Infrastructure Projects

NORJANNA M. CAMAGUIN, MPA
Chief Administrative Officer, PMO
Head, BAC Secretariat for Goods and Consulting Services

ENGR. RODERICK MILANA, REA Provincial Assessor / BAC Member

ALLAN C. PUTONG, JD PGDH-PGSO / BAC Member

ENGR. ANGELIE R. GELLA APGDH-PEO / BAC Member

**DOMINIC BUCOL, JD**PGDH-PCSMO / BAC Member

RAUL R. FUECONCILLO, LAgri.MAg.Dev. Provincial Agriculturist / BAC Member

RAUL D. RAUT, ENP, JD
PGDH-PHRMO / BAC Vice-Chairperson

DESSAMIE BUAT-SANCHEZ, CPA, JD PGDH-PBO / BAC Chairperson Presiding Officer

Approved by:

YVONNE ROÑA CAGAS
Governor
Head of Procuring Entity



### Republic of the Philippines PROVINCE OF DAVAO DEL SUR Barangay Matti, Digos City, Davao del Sur

OMES IN CHARLES OF VERNING

BIRDS AND A RESTOR COMMITTEE GLASC

### Resolution No. <u>052</u> Series of 2022

A1 OF THE 2016 REVISED IN REPUBLIC ACT NO. 9184, 0 PROCUREMENT REFORM ACT. YVONNE RONA CAGAS TO ADOPT THE SUSPENSION OF PARTICIPATING BIDDERS WHO WILL INCUR ANY OF THE VIOLATIONS STIPULATED IN SECTION 41 OF THE 2016 REVISED IMPLEMENTING RULES AND REGULATIONS OF RECOMMENDING TO THE HEAD OF MOLUTION AND THE PROPERTY OF T ZZOZZ PROCURING ENTITY, TIME. GOVERNMENT

Conference and the Instruction to Bidders: submission of biddings WHEREAS, the Provincial Government of Davao del Sur encounters failures due õ their bidding constant violations committed by the documents despite Ō, S S O participating orientation during Bidders Pre-bio in the ō

Group unanimously agreed that the following instructions are hereby issued pertaining to the implementation of the Suspension of the Participating Bidders against violations of Section 41 of the Revised IRR of RA 9184; WHEREAS, to further strengthen the integrity of the competitive bidding process, the Bids and Awards Committee together with the Members of the Technical Working

as follows: The provision of Section 41 the Revised IRR of RA 9184 is hereby reiterated

to reject contract in the following situations: "Section 41. Reservațion Clause. -グロウ and all Bids, declare The Head of the Agency reserves the right យ failure of bidding, Q not award the

- themselves, or between a bidder and nullify competition; which restricts, any of the bidders, or if the collusion is between or among the bidders officers or employees of the Procuring Entity, or between the BAC and a. If there is prima facie evidence of collusion between appropriate public between a bidder and a third party, including any act suppresses or nullifies or tends to restrict, suppress or
- procedures; or If the BAC is found to have failed in following the prescribed bidding
- c. For any justifiable and reasonable ground where the award of the contract will not redound to the benefit of the government as defined in the IRR."
- N the purpose of competitive bidding, are hereby clarified to read as follows: The violations enumerated, which are considered as acts that tend to defeat officers or employees of the Procuring Entity If there is prima facie evidence of collusion between appropriate public
- 2.b If there is prima facie evidence of collusion between the BAC and any of the bidders;



### Barangay Matti, Digos City, Davao del Sur PROVINCE OF DAVAO DEL SUR

. Nat. backer. Telefax (082) 37 x95 x97 3/3/3 at www....a valadent.cov.dt Mobile Nov. 0904-299-050-6/180-84-Jeksa at Tanandana si natukonieksi (Comiliano PAR STEEL OF 338838/-3480)/bE66785

BIDS AND LAYER AND BOLLINA

• ; . (\_

BAC Resolution No. 052 s. 2022

Page -2-

2.c themselves, or between a bidder and a third party, including any act which If there is prima facie evidence of collusion between or among the bidders competition; suppresses or nullifies or tends to restrict, suppress

- ÇΔ of its projects and maintain a tally of violations by each bidder in its jurisdiction as well as of the violations by the bidder of the said policy in other offices of the Provincial Government of Davao del Sur. The BAC through its Secretariat shall monitor the participation of bidders in all
- ١. participating bidder/contractor for the violation Section 41 of RA 9184: Spids and Awards Committee, shall recommend to the Head Entity, for approval, the administrative sanction 9 50 of the erring

ö For the first violation – an administrative penalty of suspension for three from participating in any procurement process

<u>ග</u> Provincial Government of Davao del Sur. months

Ö one (1) year from participating in any procurement process in the Provincial Government of Davao del Sur. For the second violation -- an administrative penalty of suspension for

 $\bigcirc$ For the third offense- perpetual disqualification from participating in any procurement process in the Provincial Government of Davao del Sur.

WHEREFORE, on motion of BAC Member Wilana, duly seconded by BAC Member

Putong, it was

REGULATIONS RESOLVED, as it is hereby RESOLVED, to recommend to the Procuring Entity, GOVERNOR YVONNE RONA CAGAS to ADOPT THE OF PARTICIPATING BIDDERS WHO WILL INCUR ANY OF THE GOVERNMENT PROCUREMENT REFORM ACT STIPULATED IN SECTION 41 OF THE 2016 SECUL ATIONS OF REPUBLIC ACT NO. <u>\_</u> 2016 Revised Implementing Rules NO. 9184, Otherwise Known as recommend to the Head of the SUSPENSION VIOLATIONS 

RESOLVED FINALLY, to furnish capies of this Resolution <u>5</u> 显 agencies

concerned for their information and guidance.

Cagas Sports and Business Complex, Barangay Matti, Digos City, Province of Davao del this 14th day of July, 2022. UNANIMOUSLY APPROVED at the Almendras Hall, Governor Douglas Ralota

I hereby certify the correctness of above-mentioned resolution

Agricultural Technologist Head, BAC Secretariat (Infrastructure Projects) engr. Shiela mae zapanta, mpa

> norja<u>nka m</u> qamaguin, mpa 100 K

Head, Consulting Services) BAC Secretariat <u>a</u>nd

( ) 



## Barangay Matti, Digos City, Davao del Sur PROVINCE OF DAVAO DEL SUR

Telefax: (082) 5:55-95 / 9/ Widniks: www.dbwnodelsur.gov.ph Mobile Nos: 0%0f 289-0576/02/03-3 22-13/27/10/68-768-5848

nich Addir bacidavis salsti Ze GMT: ചക്കിയ പ്രത്യേത്താരെക്കു ക്രൂന്ദ്രിയത シンエが深つで

052 s. 2022

0000

17.

Page -3-BAC Resolution No. X-X-X-X-X-X-X-X-X-X-X-X-X-X

Aitested by:

DOMINÍK S. BUCOL JD PGDH-Provincial Warden Office EAC Wember

Engr. APGDH-PEO BAC Member 

Land Putong BAC Member

> FUECONCILLO, MagDev Š **BAC Member** PGDH-OPAG eave

Engr. RODERICK R. MILANA, REA PGDH-PASSO BAC Member

BAC Vice Chairperson PODH-HRMO BIRAUT, End, JD

dessamie bua't sanchez, cpa, jd BAC Chairperson - Presiding Officer Provincial Budget Officer

Approved by:

Head of Procuring Entity MNE RONA Governor

### Barangay Matti, Digos City, Davao del Sur mobile Nucl 6911 1931 Toma La Tarando delses goven Telesac (1811) inches a carando delses goven province of dayao del sur جعسساطاساس كالمه باساسهاجات

n Audit baoudayand nesetik CALIFOR PROGRAMOS CONTROL CONT

Series of 2022

### A RESOLUTION

RECOmmending to the head of the procuring entity, governor yvonne rowacas, to declare bidders who failed to disclose all on-going projects as disqualified, after finding such non-inclusion during post-qualification of bidders by the bac technical working group (twg).

Be it enacted by the BAC MEMBERS in meeting assembled:

WHEREAS, in line with the Provincial Government of Davao del Sur's initiative to fast-track procurement transactions of the Province, the Special Bids and Awards Committee thereby adopts Resolution to produce Contractors with integrity and truthfulness in their submitted bid; the e

WHIEREAS, item number 2 of GPPB NPM 111-2013 states that, "Failure to include all on-going and completed contracts in the Statement may be a ground for disqualification for being incomplete, and may of the documents or the submission of an otherwise incomplete or patently insufficient document, disqualify the bidder based on the non-discretionary "pass/fail" criterion under Section 30.1 of the IRR documents. The submission of the eligibility documents enumerated in Section 23.1 of the IRR is a mandatory requirement that must be complied with by prospective bidders, such that failure to submit any also result in blacklisting if proven that such failure amounts to submission of false information or false Section 23.1 of the IRR is a will , "

contract, including contracts awarded but not yet started, if any, whether similar or not similar in nature and complexity to the contract to be bid is a ground for disqualification. These contracts, as reflected in the "Statement of all on-going contracts", are vital to the computation of the Net Financial Contracting Capacity of the bidder, and they are necessary information during the post-qualification stage to verify, validate and ascertain the technical qualification of the Lowest Calculated Bidder for the ultimate determination whether IIN ADDITION, GPPB NPVI 006-2018 states that, "Failure to declare an on-going government and private Lowest Calculated and Responsive Bidder.

WHEREFORE, after thorough deliberation, BAC Member Milana duly seconded by BAC Member Putong.

Resolved, as it is hereby resolved, to recommend to the HEAD of procuring entity, governor yvonnerona cagas, to declare bidders who failed to disclose all ongovernor yvonnerona cagas, to declare bidders who failed to disclose all ongoing projects as disqualified after finding such non-inclusion during post-qualification of bidders by the bac technical working group (twg);

and guidance RESOLVED FINALLY, to furnish copies of this Resolution to all agencies concerned for their information

Business Complex, UNANIMOUSLY APPROVED at the Almendras Hall, Governor Douglas Raiota Cagas Sports and Barangay Matti, Digos City, Province of Davao del Sur, this 14th day of July, 2022 Barangay Watti,

I hereby certify to the correctness of above-mentioned resolution

Agricultural Technologist Head, BAC Secretariat (Infrastructure Projects) engr. Shjela mae zapanta, mpa

> PURPLEOR ,100 00T **3** CAMAGUIN, MPA

Head, BAC Secretariat (Goods and Consulting Services)

BAC Resolution No. @53. Ŏ, <u>ئى:</u> Series of 2022

DOMINIC/S/BUCOL JD PGDH-Provincial Warden Office /BAC Member

Engi. ANGELIE R. G APGDH-PEO BAC Member 

(on leave)
RAUL R. FUECONCILLO, MagDev
PGDH-Office of the Provincial Agriculturist
BAC Member

Engil RODERICK R. MILANA, REA PGDH-PASSO BAC Member


ALLANIC. PUTONG) PCDH-PGSO BAC Member 

> MADI BAC Vice Chairperson PGDH-HRMO D'RAUT, EnP, JD

DESSAMIE BUAT-SANCHEZ, CPA, JD PGDH - PBO BAC Chairperson — Presiding Officer

Approved by:

YVOMME ROMA Head of Procuring Entity Governor -

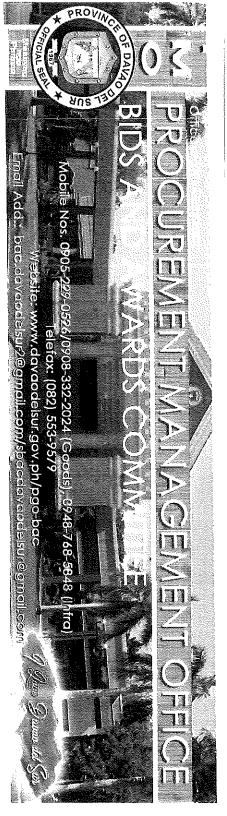


# TWG - CHECKLIST FOR BID EVALUATION


	- Marian - M	
	The second secon	
		İ
		- 1
The state of the s	The state of the s	
миненти	- Comments	5. Health and Safety
White and the second sec		4. Photographs
		Assistance to the Engineers
		Consumables
		Equipment, Survey Equipment and
		<ol><li>Furnishing of Furniture, Laboratory</li></ol>
The standard of the standard o	- TANAMAY PARAMANANANANANANANANANANANANANANANANANAN	(Rental Basis)
		<ol> <li>Field/ Laboratory Office &amp; Living Quarters</li> </ol>
the state of the s		not be subjected to OCM mark-up:
		J. The following non-civil work items shall
The state of the s		the EDC, OCM, and Profit.
		I. VAT Component shall be 5% of the sum of
		the projects 5 million and below.
		EDC for projects above 5 million and 10% for
		H. Contractor's Profit Margin shall be 8% of the
A THE SAME OF THE		
		<ul> <li>G. Miscellaneous expenses must be within the</li> </ul>
The state of the s	HAVWAG SIGNET	
		F. Contingencies must be within the range of
		E Overhead expenses must be within the range
		EDC) of the civil works items.
	***************************************	
		Mobilization and demobilization shall not
		<li>C. Allowance for waste and/or losses, not to</li>
		BOQ.
		≓
		<ul> <li>B. The amount in the Detailed Estimates must</li> </ul>
111100000000000000000000000000000000000		
		-
		3. Detailed Estimates
		End-User.
		<ol><li>Bill of Quantities submitted by the contractor must</li></ol>
	WARAN PARTY .	1 Bid Amount (both in words and in figure) must be
REMARKS	FINDINGS	
		Contractor:
		Name of Project:
	A CONTRACTOR OF THE CONTRACTOR	IB No.
- Linuxini i i i i i i i i i i i i i i i i i i		



	E. Cash Flow by quarter and payment schedule (check mathematical computation against the bid amount)	E. Cash Flow mathema
	D. Bid Securing Declaration (must be in prescribed form, 15 days)	D. Bid Securing L form, 15 days)
	(2%) C. Surety Bond callable upon demand (5%)	(2%) C. Surety Bo
	Bank Guarantee/ Draft or Irrevocable Letter of Credit	B. Bank Gu
	A. Cash or Cashier's/ Manager's check (2%)	A. Cash or C
The state of the s		A Dia opciett
Ti can dell'ori chi.		
The second secon	The state of the s	
The state of the s	Permits and Clearances	.0
100000000000000000000000000000000000000	Provision of Service Vehicle	В
	. Mobilization and demobilization	A.
	K. The following items shall not be subjected to OCM and Profit mark-up:	
TOTAL PROPERTY OF THE PROPERTY		

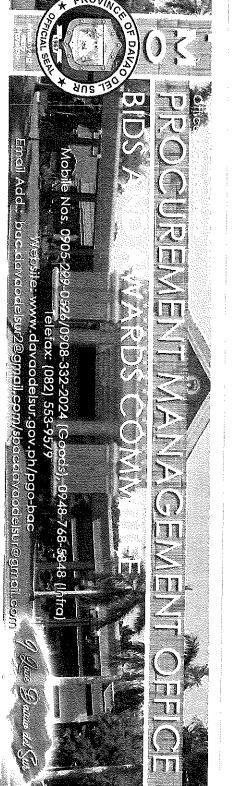

IB. No.	FICATION	7,000
Name of Project:	- Andrews	HAMPLE .
TECHNICAL DOCUMENTS:		
1. Not a Blacklisted Contractor per GPPB Website	7.000	
proprietorship, or CDA for cooperatives must be valid (Company Name and Validity)		
Mayor's/ Business permit must be valid (Company Name and Validity)	optioning in the second	
4. Tax Clearance must be valid (Company Name and	Very production of the second	
5. PhilGEPS Registration (Platinum Membership) must	1000 mm	
6. Valid Philippine Contractors Accreditation Board or Special PCAR I icense in case of loint Venture		THE TAXABLE PROPERTY.
(PCAB)		
7. Statement of all on-going government and private contracts including awarded but not yet started	THE PARTY NAMED IN COLUMN TO THE PARTY NAMED	
A. Complete attachments		
I. Notice of Award		
II. Contract  Notice to Proceed		
B. Evaluate the projects, if any:		
i. Verify Target Date of Completion		
more than fifteen percent (15%) in any		
one project or a negative slippage of		
C. Verification of on-going projects via DPWH	- No	
Statement of the bidder's Single Largest Completed		1,774,174,174
Contract (SLCC) similar to the contract to be bid for the last (3) years, and whose value additional to		
current prices using the PSA consumer price indices,		
must be at least fifty percent (50%) of the ABC to		
Small A and Small B categories without similar		
experience on the contract to be bid may be allowed	****	
to bid if the cost of such contract is not more than		
their registration based on the guidelines as		
prescribed by the PCAB.		
Must be supported with the following:  A Contract / Burchase Order	To the state of th	AAAAAAA
B. Certificate of Completion / Acceptance or	111111111111111111111111111111111111111	
C. Validate Contractors/Constructors Performance	**************************************	THE PARTY OF THE P
Evaluation System (CPES) in DPWH website.		Control of the contro

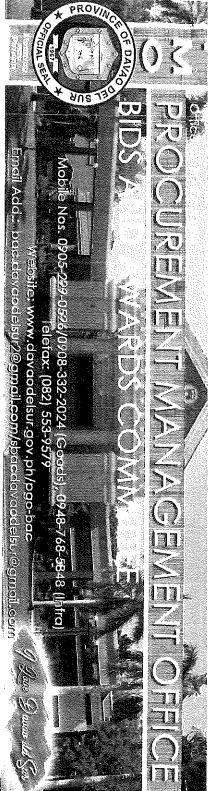

Managaria Managa	and Standards
The state of the s	19. Duly Notarized Compliance to Existing Labor Laws
100000000000000000000000000000000000000	18. Duly Notarized Affidavit of Site Inspection
TO THE PARTY OF TH	<ol><li>17. Equipment Utilization must conform with the POW</li></ol>
	<ol><li>Manpower Utilization must conform with the POW</li></ol>
TO THE STATE OF TH	15. PERT-CPM must conform with the contract duration
	amount
	with the prescribed contract duration and the bid
T CONTROL OF THE CONT	<ol><li>14. Construction schedule and S-Curve must conform</li></ol>
	approved plan
PARIMATAL Lib.	13. Construction Methods must conform with the
	2021
THE PROPERTY OF THE PROPERTY O	12. Business Tax Return Quarterly or Monthly as of
The date of the second	11. Income Tax Return as of 2020
	reconciled with the Audited Financial Statements
THE HAMPY AND ADDRESS OF THE PROPERTY OF THE P	10. Net Financial Contracting Capacity (NFCC) must be
	form (1 to 9) and duly notarized
The second secon	<ol><li>Omnibus Sworn Statement must be in prescribed</li></ol>
	THE PROPERTY OF THE PROPERTY O